KAWARTHA PINE RIDGE DISTRICT SCHOOL BOARD PUR24-070-ITT

Dr M.S. Hawkins Public School Classroom Upgrades

ADDENDUM NO. 3

This addendum shall form an integral part of the bid documents for the above noted Bid and shall be read in conjunction therewith. This addendum shall, however, take precedence over all requirements as it pertains to the particular and specific items noted below.

PART 1: ANSWERS TO QUESTIONS

Question 1:	Note 2A of A200 – This item mentioned remove existing metal caps and
	embedded pipes. But mechanical drawing does not indicate removal of existing
	metal caps & embedded pipes. Please more detail of how slab is repair at these
	locations.

Answer 1: Please refer to Part 2 Additional Information, Add (2) Below

Question 2: Please advise whether removal and replace existing caulking on door fames at room 244, 245, 246 and 247 is required.

Answer 2: Please refer to Part 2 Additional Information, Add (2) Below

Question 3: Who will remove & reinstall smart board?

Answer 3: Please refer to Part 2 Additional Information, Add (2) Below

Question 4: Unit ventilators are to be removed to install flooring underneath. But this requirement is not mentioned in mechanical drawing.

Answer 4: Please refer to Part 2 Additional Information, Add (2) Below

Question 5: Cover of existing radiators are to be removed to install new flooring underneath. But this requirement is not mentioned in mechanical drawing.

Answer 5: Please refer to Part 2 Additional Information, Add (2) Below

Question 6: Who will remove the existing ceiling support system where asbestos containing glue- on ceiling tiles is to be removed? Pre-qualified abatement contactor or

selective demolition contractor?

Answer 6: Please refer to Part 2 Additional Information, Add (2) Below

Question 7: Who will remove and reinstall WI-FI APS?

Answer 7: Please refer to Part 2 Additional Information, Add (2) Below

Question 8: Demolition Note 20 of drawing A200 – Provide location & typical section of 16mm

drywall enclosure on 92mm metal stud if required.

Answer 8: Please refer to Part 2 Additional Information, Add (2) Below

Question 9: Item 1.3.9 of Section 02 81 00 – Is this item include removal of millwork items?

Answer 9: Please refer to Part 2 Additional Information, Add (2) Below

Question 10: Note 25 of drawing A200 – We are not able to decide which areas need self-

leveling underlayment, until we remove the existing flooring. We therefore suggest to include self-levelling underlayment to Cash Allowance or provide tentative quantity of self-levelling underlayment area for us to include in bid price.

Answer 10: Please refer to Part 2 Additional Information, Add (2) Below

Question 11: Note 26 of drawing A200 – Which windows painting and caulking? Please

confirm that painting is required window frame interior side only.

Answer 11: Please refer to Part 2 Additional Information, Add (2) Below

Question 12: Who are the base building contractor for following works?

- Mechanical control

- Fire alarm

- Access control

- Network and telephony cabling, telephone, WI-FI APS, Audio-visual work,

clocks, projector screen work and other communication works

Answer 12: The base building contractors are:

Mechanical Controls – Set Point

-Fire Alarm and Access – Trent Security

- The rest are all KPR internal IT Department

PART 2: ADDITIONAL INFORMATION

Add (1): Appendix C - Pricing

(f) When the pricing form labelled **Subcontractor Pricing** is included in the Bidding System, under the Schedule or Prices section, bidders must follow the instructions below:

Pricing submitted in this form is to be incorporated in the Total Contract Amount and shall not be considered an addition or extra. Pricing is to exclude HST.

Bidders must choose from the list of prequalified subcontractors listed in Section B of the ITT Particulars (Appendix D).

Bidders shall state only one (1) sub-trade or supplier for each type of work. Bidders shall not indicate "TBD" (To Be Determined) or "TBA" (To Be Announced) or similar wording. Where the Prime Contractor shall complete the work indicate "own forces" (if pre-qualified subcontractors are listed the Prime Contractor cannot indicate "own forces" and must use one of the prequalified contractors). Wherever the term own forces is used, these persons shall be bonafide employees of the Prime

Contractor. Following submission, no subtrade or supplier may be substituted from this list without Board approval.

Should prequalified subcontractors be required to attend the Mandatory Site Meeting as indicated in Part 1 – Invitation and Submission Instructions, 1.5.2 Site Visit / Pre-Bid Meeting, bidders will be required to only choose from those subcontractors that attended.

Add (2): Addendum No. 2. Project No. 23A117, prepared by CMV Group architects, dated

April 16, 2024, (7 pages)

Add (3): Mechanical Addendum M-1 dated April 16, 2024, by TMP attached, Addendum

No 3, Project No 23A117, prepared by CMV Group architects, (4 pages)

Delete (1): Appendix C - Pricing

(f) When the pricing form labelled **Subcontractor Pricing** is included in the Bidding System, under the Schedule or Prices section, bidders must follow the instructions below:

Pricing submitted in this form is to be incorporated in the Total Contract Amount and shall not be considered an addition or extra. Pricing is to exclude HST.

Bidders must choose from the list of prequalified subcontractors listed in Section B of the ITT Particulars (Appendix D).

Bidders shall state only one (1) sub-trade or supplier for each type of work. Bidders shall not indicate "TBD" (To Be Determined) or "TBA" (To Be Announced) or similar wording. Where the Prime Contractor shall complete the work indicate "own forces" (if pre-qualified Abatement subcontractors are listed the Prime Contractor cannot indicate "own forces" and must use one of the prequalified Abatement contractors). Wherever the term own forces is used, these persons shall be bonafide employees of the Prime Contractor. Following submission, no subtrade or supplier may be substituted from this list without Board approval.

Should prequalified subcontractors be required to attend the Mandatory Site

Meeting as indicated in Part 1 – Invitation and Submission Instructions, 1.5.2 Site Visit / Pre-Bid Meeting, bidders will be required to only choose from those subcontractors that attended.

END OF ADDENDUM NO. 3



101 – 20 Camden Street Toronto, Ontario M5V 1V1

ADDENDUM

416.506.1600 416.506.0956

www.cmvarch.com

April 16, 2024 DATE

ADDENDUM No

ATTENTION

Steven Altpeter

Dr M.S. Hawkins Sr Public School Classroom Renovations PROJECT

23A117 PROJECT No

Kawartha Pine Ridge District School Board TO 1994 Fisher Drive Peterborough, ON K9J 6X6

This Addendum shall be attached to the form of the Specifications and shall form an integral part of the Contract.

The following drawings are issued as clarification:

Documents. The contents of this Addendum shall be brought to the attention of all concerned.

Architectural drawings A200-Revision No. 4, D202-Revision No. 4, D204-Revision No. 3, D301-Revision No. 4, and A301-Revision No. 4.

Note: Demolition and proposed notes are revised for clarification. The GC is responsible for removing and reinstalling all existing smart boards, projectors, and speakers. GC is also responsible for the supply and installation of all new smart boards.

In response to questions regarding the base building contractors: For designated contractors and controls scope of work refer to drawing A201.

In response to Question 1:

Note 2A on drawing A200, this is not a mechanical item. Remove existing metal protrusions in floors, fill voids with concrete and underlayment. See project manual section 03 53 00.

In response to Question 2:

Regarding existing caulking around the door frames see addendum #1.

In response to Question 3:

Existing smart boards and projectors etc. see revised note 7 on drawing A200. Also, see attached drawings to this addendum.

Receipt of the Addenda shall be acknowledged in the Tender Form.

All trades shall read the Addenda.

This addendum consists of 7 pages and attachments as noted.

• In response to Question 4:

Note 9 on drawing A200, note has been revised to indicate that unit ventilators are not being removed and reinstalled. New flooring is to butt up against unit ventilator enclosure.

• In response to Question 5:

Note 23 on drawing A200, existing radiator covers are to remain and be painted refer to note. Existing radiator covers do not go down to the floor; therefore, installation of flooring underneath of radiators will not be a problem.

• In response to Question 6:

Removal of existing ceiling support system, GC is responsible to coordinate with the abatement contractor per the abatement specs.

• In response to Question 7:

WIFI APs see note 19 on drawing A200.

• In response to Question 8:

Note 20 on drawing A200, new drywall enclosure is only required if removal of existing millwork exposes any openings and holes in the existing exterior wall.

• In response to Question 9:

Section 02 81 00 does not exist in our project manual.

In response to Question 10:

New floor underlayment/levelling compound,

- Proceed as specified in the Project Manual (Issued for Bid) section 03 53 00
 Cementitious Self-Levelling Underlayment.
- o Cash allowance will not be assigned to this scope of work.

In response to Question 11:

Note 26 on drawing A200, room 246A all window frames to be painted both sides. Room 233, window frame in the interior partition to be painted both sides as per the note on floor plan.

Tala Jabbary	
PER CMV GROUP ARCHITECTS	

DISTRIBUTION

Rachel Northey-Pinchin Ltd., Andrew Ferreira-TMP, Quan Vu-H&J

- (1.) ALL FURNITURE TO BE REMOVED BY OWNER.
- (2.) REMOVE AND DISPOSE OF EXISTING FLOOR TILES AND RESILIENT WALL BASE INCLUDING ALL ADHESIVES. PATCH AND MAKE GOOD CONCRETE SLAB AND WALLS TO RECEIVE NEW FLOORING AND NEW WALL BASE. PROVIDE SELF-LEVELING UNDERLAYMENT AS REQUIRED. MEET OR EXCEED SUBSTRATE REQUIREMENTS FOR CONCRETE SLAB AND WALLS AND PARTITIONS AS SPECIFIED IN THE FLOORING AND WALL BASE SPECIFICATION SECTIONS. SEE PINCHIN REPORT.
- (2A) GC TO REMOVE EXISTING METAL CAP AND EMBEDDED PIPE IN ORDER TO PROVIDE FLUSH SURFACE FOR NEW FLOORING. TYPICAL OF 36 LOCATIONS. PATCH AND REPAIR CONCRETE SLAB WITH SELE LEVELLING COMPOUND. SEE SPECIFICATIONS. MAKE CONCRETE SLAB READY FOR NEW FLOORING AS PER MANUFACTURERS REQUIREMENTS. TYPICAL
- (3.) REMOVE & DISPOSE EXISTING WALL-MOUNTED WHITEBOARDS, CHALKBOARDS AND TACKBOARDS. PATCH AND MAKE GOOD WALLS BEHIND READY FOR PAINT. SEE PINCHIN REPORT.
- (4.) REMOVE AND DISPOSE OF EXISTING DOOR AND HARDWARE. EXISTING FRAME TO REMAIN, SAND, REPAIR AND REPAINT, REMOVE ROOM/DOOR SIGNS, PATCH, MAKE GOOD SURROUNDING CONC BLOCK WALL, OR PARTITIONS TO MATCH EXTG CONDITION, READY FOR PAINT, SEE PAINT SCHEDULE
- (5.) REMOVE AND DISPOSE PART OF EXTG SOFFIT AND BULKHEAD.
- (6.) REMOVE AND DISPOSE OF EXISTING MILLWORK, SHELVING AND CABINETS. PATCH AND MAKE GOOD WALLS TO RECEIVE NEW WALL PAINT & WALL BASE
- (7.) existing projector & screen: $\mathsf{wall}/\mathsf{ceiling}$ mounted projector ani CONTROLS TO BE REMOVED BY GC. PATCH AND MAKE GOOD WALLS, CEILING, SLAB AND FLOORING. ALSO REFER TO ELECTRICAL DRAWINGS AND ABATEMENT SPECS.
- 8.) EXTG CONC BLOCK WALL. REMOVE ABANDONED/OLD CONDUITS. ELEC. ✓ ITEMS, OLD CLOCKS, BRACKETS, SUPPORTS, RAILS, HOOKS, PINS AND ALL REMAINING EXTRA ITEMS. FIX & REPAIR CRACKS & JOINTS. FILL EXTG. HOLES, REPAINT THE WALL OVER EXISTING OLD PAINT, SEE PINCHIN REPORT. EPOXY. GLUE, ADHESIVE & ETC FROM WALLS. PREPARE WALL SURFACE TO ACCEPT NEW PAINT. PATCH & REPAIR ANY DAMAGES CAUSED BY DEMOLITION. MAINTAIN EXISTING FIRE RATING SEPARATION.
- TYPICAL (9.) EXISTING UNIT VENTILATORS TO REMAIN, AND TO BE CLEANED PRIOR TO PAINTING. EXISTING FLOORING AND WALL BASE TO BE REMOVED AROUND UNIT VENTILATORS AND TO DOOR THRESHOLDS. TYP. REPAINT EXTG UNIT VENTILATORS ENCLOSURE.
- (10) RREMOVE AND DISPOSE OF EXISTING SINKS INCLUDING COUNTERTOP, MILLWORK CABINET, PAPER TOWEL DISPENSER HAND SOAP DISPENSERS, AND OTHER ACCESSORIES. SEE MECHANICAL DRAWINGS FOR REMOVALS/MODIFICATIONS TO PLUMBING. WHERE WALLS AND SLABS ARE DAMAGED BY THE REMOVALS, PATCH AND MAKE GOOD WITH LIKE ASSEMBLIES, MATERIALS AND FINISHES. FLOOR SLAB AND WALL PATCHES TO BE SMOOTH, LEVEL AND PLUMB. SEE PINCHIN REPORT.
- (11.) REMOVE AND DISPOSE CLOSETS ENTIRELY INCLUDING DOORS, FRAMES SHELVES AND HARDWARE GC TO REMOVE EXTG CAULKING ON DOOR
- (12.) EXISTING ELECTRICAL PANEL, REPAINT OR PROVIDE NEW COVER. REFER TO ELEC. DWG.
- (13.) REMOVE AND DISPOSE OF EXISTING PA SPEAKER PHONE, CALL SWITCH, ✓ AND BACKBOARD. SEE ELECTRICAL DRAWINGS.
- (14.) FOR HEAT AND SMOKE DETECTORS REFER TO MECH. AND ELEC. ORAWINGS.
- (15.) REMOVE TRIM AT WINDOW SILL AND REPLACE WITH NEW.
- (16.) REMOVE AND DISPOSE EX. LIGHT FIXTURES, EX. MECH. VENTS, DIFFUSERS, AIR SUPPLY GRILLES AND ALL CEILING MOUNTED ITEMS. EXISTING CONDUITS OR PIPING SUSPENDED FROM CEILING SLAB AT HIGH LEVEL TO REMAIN UNLESS NOTED OTHERWISE. SEE MECH. & ELEC. DRAWINGS. SITE VERIFY QUANTITIES AND EXTENT.
- (17.) REMOVE AND DISPOSE OF EX. CEILING TILES AND CEILING SUPPORTING SYSTEM INCLUDING TILES, GYPSUM BOARD, FURRING CHANNELS, HANGERS AND EX. LIGHT FIXTURES, MECH DIFFUSERS, VENT AND ALL CEILING MOUNTED ITEMS UNLESS NOTED OTHERWISE. SEE MECH. AND ELEC. DRAWINGS, SEE PINCHIN REPORT.
- (18.) REMOVE AND REPLACE WOODEN WINDOW VALENCE & SILL BOARDS. SEE ' A800 DRAWING.
- (19.) EXISTING WI-FI APS TO BE REMOVED BY THIS CONTRACTOR, PRIOR TO DEMOLITION, AND KEEP SAFE UNTIL END OF CONSTRUCTION AND REINSTALLED IN THE EXACT SAME ROOM TO NEW LAYOUT CENTERED IN NEW CEILING. GC ELECTRICIAN TO COORDINATE WITH ELEC CONSULTANT.
- 20) REMOVE EXTG WALL/TRIM AT LOCATION OF EXTG UNIT VENTILATORS. PROVIDE CLEAR SPACE FOR INSTALLATION OF NEW MILLWORK WITH NEW AIR GRILLES. CLOSE ADJACENT OPENINGS & HOLES. INSTALL 16MM DRYWALL ENCLOSURE ON 92MM ST STUD IF REQ'D.
- (21) EXISTING DUCTWORK AND ACCESS PANELS TO REMAIN. REFER TO
- (22) EXISTING GLASS AND HOLLOW METAL FRAME TO REMAIN.
- (23) EXISTING RADIATOR TO REMAIN, AND TO BE CLEANED PRIOR TO PAINTING. EXISTING FLOORING AND WALL BASE TO BE REMOVED UNDER AND AROUND RADIATOR AND TO DOOR THRESHOLDS. TYP. REPAINT EXTG RADIATOR ENCLOSURE.
- (24) EXISTING DRYWALL TO REMAIN. REMOVE ABANDONED/OLD CONDUITS, ELEC igcup ITEMS,OLD CLOCKS BRACKETS, SUPPORTS,RAILS HOOKS. GC TO PATCH, REPAIR ANY DAMAGES AND HOLES CAUSED BY DEMOLITION AND PAINT THE DRYWALL OVER EXISTING PAINT TO MAKE IT GOOD AS NEW. MAINTAIN EXTG. FIRE RATING THROUGHOUT THE WALL. TYPICAL. SEE PINCHIN

- (25) NEW LVT FLOORING: HIGH PERFORMANCE LUXURY VINYL TILE (LVT) FLOORING, INTERFACE STUDIO SET. CLASS III PRIMED. COMMERCIAL GRADE, FINISH CERAMOR, SLIP RETARDANT. 250MM X 1000MM X 4.5MM, PROVIDE ACCENT BAND & NEW RESILIENT TRANSITION STRIP. PROVIDE SELF-LEVELING UNDERLAYMENT AS REQUIRED. MEET OR EXCEED SUBSTRATE REQUIREMENTS FOR CONCRETE SLAB AS SPECIFIED IN THE FLOORING SPECIFICATION SECTION. SUB-FLOOR SHALL COMPLY TO ASTM F 710 STANDARD PRACTICE FOR PREPARING CONCRETE FLOORS TO RECEIVE RESILIENT FLOORING. LVT FLOORING SHALL BE EXTENDED BELOW BOOKSHELVES/CABINETS MILLWORK CLOSET AND EXTG RADIATORS. GC TO SUBMIT 3 SAMPLES FOR ACCENT STRIPE/BORDER AND 3 SAMPLES FOR FLOORING, GC TO PROVIDE INSTALLATION METHODS MOCK UP FOR REVIEW & APPROVAL. PROVIDE 15 YEAR STANDARD LVT WARRANTY- REFER TO A501 FOR FLOOR PATTERN, AND A801 FOR FINISH SCHEDULE AND SPECIFICATION
- (26) EXISTING WINDOW FRAME TO REMAIN. PATCH, SAND REPAIR, AND PAINT ALL FRAMES REMOVE DIRT AND DEBRIS FROM THE WINDOW FRAME AND GLASSES. WASH, CLEAN, AND REMOVE OXIDATION FROM FRAME, REMOVE EXTG CAULKING, RE-CAULK AROUND FRAMES. MAKE GOOD FRAMES SO THAT GLASS AND FRAME LOOK AS NEW.
- 27) NEW RUBBER BASE, 102MM X 3MM THICK RUBBER COVE BASE SEE SPECIFICATION. PROVIDE SELF-LEVELLING UNDERLAYMENT AS REQUIRED. MEET OR EXCEED SUBSTRATE REQUIREMENTS FOR WALLS AND PARTITIONS AS SPECIFIED IN THE WALL BASE SPECIFICATION SECTION.
- (28) EXISTING DUCTWORK TO REMAIN. THOROUGHLY CLEAN THE SURFACES OF THE EXISTING DUCTWORK TO REMOVE ANY DUST, DIRT OR LOOSE PARTICLES. SAND AND PAINT ALL THE SURFACES. SEE MECHANICAL DRAWINGS.
- 29) 1HR FIRE SEPARATION ENCLOSURE, EXTG CONC BLOCK WALL OR EXTG/NEW DW PARTITION: ENCLOSING WALLS ARE REQUIRED TO HAVE A MIN 1HR FIRE-RESISTANCE RATING. EXISTING & NEW HOLES SHALL BE PATCHED REPAIRED AND SEALED WITH MIN 1HR FRR FIRE STOPPED / CAULKING SO THAT THE INTEGRITY OF THE FIRE SEPARATIONS IS MAINTAINED THROUGHOUT. APPLY FIRESTOP BELOW THE ROOF DECK AT TOP OF EXTG CONC BLOCK WALL ALONGSIDE OF THE CORRIDOR. DETAILS TO COMPLY WITH ULC STANDARDS.. PROVIDE SHOPDWG. FILL EXTG & NEW OPENINGS TO MAINTAIN EXTG FIRE SEPARATION, COMPLY TO ULC RELATED DESIGN NO. AND TO SATISFY BUILDING INSPECTION.
- (30) RESERVED.
- (31) NEW PAINT/ REPAINT INTERIOR WALLS, BULKHEADS, DOOR FRAMES, WALL FIN COVERS. UNIT VENTILATOR COVERS, OLD AND NEW METAL CAPS. PROVIDE NEW PAINT FINISH ON ALL INTERIOR PAINTABLE SURFACES. MAKE ALL THE FINISHES GOOD. SEE FINISH SCHEDULE AND SPECIFICATION. PRIME AND PAINT ALL SURFACES OVER THE OLD PAINTING, SEE PINCHIN REPORT.
- (33) PATCH, REPAIR AND PAINT EXISTING FRAME OVER THE OLD PAINT. SEE PINCHIN REPORT. SUPPLY & INSTALL NEW DOOR WITH NEW HARDWARE AND DOOR NUMBER/ROOM NAME SIGN. (CONFIRM DIMENSIONS ON SITE PRIOR TO ORDERING). SÉE DOOR SCHEDULE, SIGNS DETAIL AND SPECIFICATION.
- 34) SUPPLY AND INSTALL NEW DOOR AND FRAME AND HARDWARE. CONFIRM DIMENSIONS ON SITE. SEE DOOR SCHEDULE AND SPECIFICATION. GC TO PROVIDE NEW CAULKING ON DOOR FRAME
- (35) WINDOWS AND NEW BLINDS: REMOVE DIRT AND DEBRIS FROM WINDOW FRAME AND GLASSES, WASH, CLEAN, REMOVE OXIDATION FROM ALUMINUM FRAME. CHECK OPENING HARDWARE AND REPLACE IT. REMOVE EXTG CAULKING. RE-CAULK AROUND FRAMES INTERIOR SIDE ONLY. MAKE GOOD ALUMINUM WINDOWS & FRAME SO THAT GLASS AND FRAME LOOK AS NEW. SUPPLY AND INSTALL NEW BLINDS TO KPRDSB STANDARDS. PROVIDE CUTSHEET &
- (36) EXISTING HM/SCW DOOR, FRAME AND HARDWARE TO REMAIN. EXERCISE CAUTION TO AVOID ANY DAMAGE TO DOOR AND ITS COMPONENTS. IN EVENT OF ANY DAMAGE, GC TO PROMPTLY PATCH, PAINT AND REPAIR ANY DAMAGE DONE TO THE DOOR OR ITS COMPONENTS AND RESTORE THEM TO THEIR ORIGINAL CONDITION AT THEIR OWN COST.
- (37) PROVIDE NEW VENTILATION GRILLE CONTINUES AT TOP & BASE OF MILLWORK. REFER TO SPEC & MECH. DWG. SUBMIT CUTSHEET FOR APPROVAL.
- (38) ARCHITECTURAL MILLWORK: PROVIDE NEW ARCHITECTURAL MILLWORK INCLUDING TEACHER CLOSETS, BOOKCASE UNITS, SHELVING UNITS, CABINETS, AND SO ON c/w 19MM ADJUSTABLE SHELVES. GC TO REVIEW EXISTING RADIATOR & PLUMBINGS CONTROLS. LOCATE CONTROL AND COORDINATE WITH MILLWORK. PROVIDE AN ACCESS PANEL IN THE MILLWORK IN ORDER TO GAIN ACCESS TO CONTROL FOR FURTHER MAINTENANCE. PNEUMATIC VALVE REMOVAL BY APS, NEW ELECTRIC CONTROLS CONNECTED TO BAS, SEE MECH. AND ELECT. DWGS.SEE A500 SERIES DRAWING, SEE SPEC, PROVIDE SHOPDWG & MOCK UP.
- 39) ARCHITECTURAL MILLWORK: NEW COAT HOOKS. SEE A800 SERIES SEE SPEC,
- PROVIDE SHOPDWG. NEW SINK, COUNTERTOP & MILLWORK CABINETS, SEE A300 & A500 SERIES. SEE SPECIFICATIONS.
- (41) NEW 1HR FFR T-BAR CEILING c/w NEW LIGHT FIXTURES, DIFFUSERS, SEE MECH & ELEC DWGS. 1HR FIRE RATED CEILING TO COMPLY WITH ULC #P210 - 610MM X 1220MM, MIN. NRC OF .70, CAC MIN. 40, FIRE GUARD; CGC RADAR HIGH NRC/CAC PANELS 22541 OR ARMSTRONG SCHOOL ZONE FINE FISSURED 1811. LAY IN EXPOSED TEE SYSTEM "DX" 24MM WIDE FACED T-BAR BY CGC OR SUSPENSION SYSTEM EQUIVALENT GRID BY CHICAGO METALLIC, OR ARMSTRONG WITH COMPATIBILITY CEILING TILES. GRID IS RATED. ALL TILE AND SUSPENSION SYSTEMS SHALL BE FIRE RATED TO CONFORM TO U.L.C. DETAIL P210. SOUND ABSORPTIVE PREFABRICATED ACOUSTICAL UNITS SHALL COMPLY TO CAN/CGSB 92.1. PROVIDE LAYOUT SHOPDWG AND
- (42) NEW DW BULKHEAD & CEILING- PAINTED, INSTALLED ON SHAFTWALL ST STUD SUPPORTS. GC TO PROVIDE MINIMUM 1 HOUR FIRE SEPARATION c/w FIRESTOPS, CAULKING & SMOKE SEAL. PROVIDE P-ENG STAMPED SHOPDWGS FOR STEEL STUD FRAME. TYP.
- (43) RESERVED.
- (44) CLEAN CEILING AREA THROUGHOUT INCLUDING STRUCTURE, DECKING, ELEC AND MECH ITEMS. REMOVE DIRT, DUST AND AIRBORNE CONTAMINANTS, REMOVE POSSIBLE MOLD AND MILDEW. PAY CLOSE ATTENTION TO ELECTRICAL CONDUITS, CONNECTIONS AND FIXTURES. REPAIR CEILING AND DECK OPENING AFTER REMOVAL OF OLD ELECTRICAL & MECHANICAL, LIGHT FIXTURES, DUCTWORK, DIFFUSERS, PLUMBING PENETRATIONS. PROVIDE FIRE STOP AT OPENINGS TO MAINTAIN 1HR FIRE SEPARATION.
- SPECIALTIES, EQUIPMENT & ACCESSORIES
- 45) SUPPLY AND INSTALL SCHOOL CONTROL PANEL C/W CLOCK, THERMOSTAT, LIGHT SWITCHES, PA CALL SWITCH, PA SPEAKER, DUPLEXES, FIREALARM AND PROVISION FOR SPACE SENSOR. STANDARD COLOUR CHOSEN BY ARCHITECT PROVIDE SHOPDWG. SEE ELECTRICAL DRAWINGS. CLOCKS TO BE BATTERY OPERATED, RO UND, SIMPLEX, TO FIT WITHIN THE SPACE AVAILABLE. CONTROL PANEL TO BE SUPPLIED AND INSTALLED BY ELEC CONTRACTOR.
- (46) SUPPLY AND INSTALL NEW WALL-MOUNTED INTEGRATED INTERACTIVE BOARDS DA-LITE IDEA SCREEN COMBINATION PROJECTION SCREEN AND WRITABLE MARKER BOARDS AS MANUFACTURED BY DA-LITE (1800-622-3737). 1350 (H) X 2170 (W) C/W CONTROLS. INSTALL ON STEEL BRACKETS BOLTED. PROVIDE SUPPORTS PER MANUFACTURER GUIDELINE. OWNER WILL REMOVE EXISTING INTEGRATED INTERACTIVE BOARDS, GC TO SUPPLY AND INSTALL NEW. SEE SPECIFICATION. SEE ARCH FLOOR PLAN & ELECTRICAL DRAWINGS.
- (47.) NEW WALL-MOUNTED MAGNETIC WHITE BOARD MANUFACTURED BY ARCHITECTURAL SCHOOL PRODUCTS OR EQUIVALENT PRODUCTS AS SUPPLIED BY GLOBAL SCHOOL PRODUCTS INC. PROVIDE SUPPORTS. C/W CLEAR ANODIZED ALUMINUM FRAME. MAP RAIL WITH CORK INSERT. REQ'D DIVIDER STRIP AND MARKER/CHALK TRAY. INSTALL MAP RAIL OVER MARKER BOARDS.
- (48) CHARGING STATION, PROVIDED BY OWNER, GC TO COORDINATE FOR LAYOUT OF POWER RECEPTACLES & INSTALLATION. RELOCATE EXISTING TOWERS WHERE SHOWN ON DRAWINGS. SEE ELEC. DWG.

- (49) CABINET UNIT HEATER: CLEAN AND COMB EXISTING CABINET UNIT HEATER, & PROPOSED DWGS. WALLFIN AND COVERS. REPAIR DAMAGED/DEFORMED CABINET UNIT HEATER COVERS OR PROVIDE NEW COVERS, GC TO SITE VERIFY CONDITIONS. FIX & FASTEN LOOSE COVER PARTS. REPAIR DENTS & SCRATCHES. APPLY NEW PAINT ON ENTIRE CABINET UNIT HEATER COVERS. PANT COLOUR TO MATCH BIRCH MILLWORK. GC TO COORDINATE WITH MILLWORK SUPPLIER TO PROVIDE ACCESS DOOR TO ALL VALVES & CONTROLS AND MATCHING PAINT COLOUR.
- (50) UNIT VENTILATORS: CLEAN AND COMB EXISTING UNIT VENTILATORS, WALLFIN AND COVERS. REPAIR DAMAGED/DEFORMED UNIT COVERS OR PROVIDE NEW COVERS, GC TO SITE VERIFY CONDITIONS. FIX & FASTEN LOOSE COVER PARTS. REPAIR DENTS & SCRATCHES, APPLY NEW PAINT ON ENTIRE UNIT COVERS. PANT COLOUR TO MATCH BIRCH MILLWORK. GC TO COORDINATE WITH MILLWORK SUPPLIER TO PROVIDE ACCESS DOOR TO ALL VALVES & CONTROLS AND MATCHING PAINT COLOUR. PROVIDE 3 SAMPLES COLOUR FOR REVIEW& APPROVAL. ALL CONTROLS SHALL TIE INTO THE BAS. SEE MECH DWG.

PROVIDE 3 SAMPLE COLOURS FOR REVIEW& APPROVAL. ALL CONTROLS SHALL

- (51.) RADIATOR: CLEAN AND COMB EXISTING RADIATOR, WALLFIN AND COVERS. REPAIR DAMAGED / DEFORMED RADIATOR COVERS OR PROVIDE NEW COVERS. GC TO SITE VERIFY CONDITIONS. FIX & PAINT ON ENTIRE RADIATOR. PAINT COLOUR TO MATCH BIRCH MILLWORK. GC TO COORDINATE WITH MILLWORK SUPPLIER TO PROVIDE ACCESS DOOR TO ALL VALVES & CONTROLS AND MATCHING PAINT COLOUR. PROVIDE 3 SAMPLE COLOURS FOR REVIEW & APPROVAL. ALL CONTROLS SHALL TIE INTO THE BAS. SEE MECH. DWGS.
- (52.) ALL EXISTING LIGHT FIXTURES TO REMAIN. SEE ELECTRICAL DRAWINGS.
- (53) NEW LIGHT FIXTURE SHALL COMPLY TO REQUIREMENT OF INCENTIVE PROGRAM. PROVIDE WITH OCCUPANCY SENSORS, SLIDE DIMMERS TO CONTROL SEPARATE ROWS OF LIGHTS. COORDINATE W ELEC ENG.
- (54.) NEW MECH DIFFUSER AND GRILLE SEE MECH DWG

D202

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D204)

1&2

A202

1&2

A204

A501

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(Qx)

TIE INTO THE BAS. SEE MECH DWG.

- (55.) PROVIDE S.S. CUSTOM SIZED COVER PLATE ON ABANDONED ELEC OUTLET OPENING, AND AROUND DIFFUSES. ALL LOCATIONS NOT SHOWN ON THIS DWG. GC TO SITE VERIFY, TYPICAL.
- (56,) RESERVED.
- (57) PROVIDE NEW ACCESS PANEL, CONFIRM SIZES WITH MECH & ELEC. NOT SHOWN ON THIS DRAWING SET GC TO SITE VERIFY EXACT LOCATION. PAINTED
- (58) PROVIDE NEW FIRE EXTINGUISHER, NOT SHOWN IN ARCH DWGS. SEE MECH
- (59.) COMPREHENSIVE FIRST AID KIT, SUPPLIED BY OWNER, INSTALLED BY GC. NOT SHOWN IN THIS SET. GC TO COORDINATE WITH OWNER FOR NO. & LOCATIONS

[31'-0]"]

STAFF WORK

SECRETARIAL 235

PROGRAMMING 233

SCALE: 1:200

ROOM 237

CONFERENCE !

ROOM 239

(60.) EXISTING COVER PLATES TO REMAIN. PROVIDE NEW LVT FLOORING IN AND AROUND THE EXISTING COVER PLATES. TYPICAL OF 6 COVER PLATES.

- TYPICAL NOTES: (APPLY TO ALL DEMO
- CONTRACTOR TO MAKE GOOD ALL FINISHES DISTURBED TO INSTALL ALL COMPONENTS UNDER THIS CONTRACT. REFER
- PROVIDE TEMPORARY HOARDING & DUST SCREENS AS REQUIRED TO COMPLETE WORK. MAINTAIN FIRE EXITS
- GC. TO ENSURE CONTINUITY OF VAPOUR BARRIER ON ANY HOLES OCCURRING THRU SUCH CEILING / WALL, VAPOUR BARRIERS FOR WIRES, PIPES, DUCTWORK, OR ELECTRICAL BOXES. VAPOUR BARRIER MUST BE TIGHTLY SEALED WITH TAPE, CAULKING OR OTHER SUITABLE MATERIAL. CONSULTANT TO REVIEW PRIOR TO INSTALLATION OF CEILING AND WALL BOARD.
- FIRE STOPPING OF SERVICE PENETRATIONS PIPING, TUBING, DUCTS, WIRING, CONDUIT, ELECTRICAL OUTLET BOXES THAT PENETRATE FIRE SEPARATIONS SHALL BE TIGHTLY FITTED AND SEALED WITH MINERAL WOOL, GYPSUM PLASTER OR PORTLAND CEMENT MATERIAL, AS PER APPROVED ULC DESIGN COMPONENTS. SUBMIT ULC RELATED DESIGN FOR CONSULTANT TO REVIEW PRIOR TO INSTALLATION AT FLOOR, CEILING OR WALL.
- MAINTAIN CONTINUITY OF FIRE SEPARATION BEHIND ALL
- FOR EXTENT OF WORK.
- DISCONNECT OR RELOCATE ALL MECH. & ELECT. SERVICES LOCATED IN EXISTING CEILING, WHICH WILL BE COVERED BY NEW T-BAR OR DRYWALL CEILING.
- PROVIDE STEEL ANGLE LINTELS OVER ALL NEW MECHANICAL DUCTS & GRILLES THAT PENETRATE EXISTING & NEW MASONRY WALLS.
- FOR PREPARATION OF SUBSTRATE SUITABLE FOR INSTALLATION OF NEW FINISHES AS PER MANUFACTURES REQUIREMENTS.

- GENERAL NOTES APPLY TO ALL DEMO & PROPOSED DWG's:
- . REFER TO SPECIFICATION

CLASSROOM 243

CORRIDOR 247H

CLASSROOM 244

- B. THERE IS A TIMETABLE FOR THIS PROJECT, CONSTRUCTION MAY NEED TO BE SCHEDULED WITH ROTATIONAL SHIFTS, NIGHT SHIFTS AND OVER TIME WORK TO AVOID DISRUPTION TO SCHOOL TIME LIMIT. DEADLINES ARE STRICTLY ENFORCED
- START AND END OF EACH ACTIVITY BEFORE SUBMITTING THEIR PRICING PROPOSAL ACCURATE EXTENT OF DEMOLITION AND PATCH & REPAIR AREA TO BE SITE VERIFIED. SIZES SHOWN ON DWGS ARE ONLY GRAPHICS. CONTRACTORS TO SITE VISIT, EXAMINE CONDITIONS BEFORE

CONTRACTORS TO CONFIRM WITH PROJECT MANAGER/SCHOOL FOR

SEE SPECIFICATION AND SEPARATE REPORTS FOR SITE CONDITIONS & IDENTIFICATION INCLUDING HAZARDOUS BUILDING MATERIALS WITHIN THE PROJECT AREA, NOTES PROVIDED IN THIS SET OF DRAWINGS ARE FOR GENERAL REFERENCES ONLY. THE CONTRACTORS SHALL FULFILL THE REQUIREMENTS OF THE ONTARIO OCCUPATIONAL HEALTH AND SAFETY ACT AND OTHER REGULATIONS. CONTRACTOR SHALL READ AND FULLY UNDERSTAND ABOVE SPEC AND REPORTS PRIOR TO REMOVAL AND DISPOSAL

OR DECONTAMINATION OF ALL MATERIALS

- PROVIDE DUST CONTROL MEASURES, SEAL ALL EXTG DUCTWORKS AND OPENINGS AND PROVIDE TEMPORARY EXHAUST PRIOR TO DEMOLITION & CONSTRUCTION.
- C. GC MUST SUPPORT THE OWNERS EFFORTS TO PURSUE THE INCENTIVE PROGRAM. TYPICAL AVAILABLE INCENTIVE LIST IS AS FOLLOWS: LIGHTING RETROFITS, LIGHTING CONTROLS, VFDS, COOLING, BOILER RETROFITS, DEMAND-CONTROLLED VENTILATION (CO2 SENSORS), DOMESTIC HOT WATER, HEAT/ENERGY RECOVERY EQUIPMENT, CONDENSING MAKEUP AIR UNITS. CONTRACTORS MUST PROVIDE THE REQUIRED INFORMATION, RECEIPTS, ETC. GC TO CONFIRM THAT SPECIFIED LIGHTING QUALIFIES FOR THE INCENTIVE, PROVIDE CUT-SHEETS.

CLASSROOM 245

CLASSROOM 246

 $[23'-11\frac{1}{2}"]$

CLASSROOM 247

- PIPING. PAINT FINISHES TO MATCH EXTG. PROVIDE MULTIPLE
- LOCATION OF ALL MECHANICAL, PLUMBING, AND ELECTRICAL BEFORE INSTALLATION OF MECHANICAL, PLUMBING & ELECTRICAL AND FABRICATION OF MILLWORK. PROVIDE SHOPDWG FOR UTILITIES ROUGH-INS /OPENINGS LAYOUT
- FIRST AID KITS. CONFIRM LOCATION ON SITE WITH OWNER.
- UNITS. TYP.

PAINT, INCLUDING SANDING, CLEANING, PATCHING, AND CAULKING. REMOVE, SCRAPE OFF, SAND OLD PAINT COATINGS. FILL, REPAIR CRACKS, SAND AND MAKE GOOD DAMAGED, DENT SURFACES & SCRATCHES. TEST OVER-COATABILITY/ RE-COATABILITY. SEAL, PRIME AND PAINT EXISTING AND NEW WALL, CEILING, DOOR & FRAME SURFACES AS INDICATED, CLEAN UP. ON WOODEN DOOR OLD STAIN COATING SHALL BE REMOVED COMPLETELY. APPLY 4 COATS OF URETHANE VARNISH OVER SEMI-TRANSPARENT STAIN ON WOOD DOOR. PAINT PREVIOUSLY PAINTED CONDUITS AND MOCK UP /SAMPLES FOR BOTH WALL & DOOR PAINTS.

PROVIDE SIGNAGE FOR EACH DOOR AND ROOM. ALL SIGNAGE TO COMPLY WITH OWNER/SCHOOL CRITERIA & OBC. SUBMIT SIGNAGE SHOP DRAWING PRIOR TO MANUFACTURE. SEE DETAIL A801.

EXTEND FLOORING INTO ENTRY DOORS. PROVIDE FLUSH METAL EMBEDDED TRANSITION STRIP LOCATED AT LINE OF ENTRY DOORS.

GENERAL CONTRACTOR TO INSTALL PAPER TOWEL DISPENSER &

M. SUPPLY AND INSTALL NEW FLOOR FINISH BELOW NEW MILLWORK

APR. 16, 2024 | ADDENDUM #2

ALL DRAWINGS ARE THE PROPERTY OF THE ARCHITECT AND MUST BE RETURNED ON REQUEST.

ALL DIMENSIONS ARE GIVEN IN MILLIMETRES UNLESS OTHERWISE INDICATED

REVISIONS AND DISTRIBUTION LOG

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MAR. 12, 2024 ISSUED FOR TENDER

APR. 15, 2024 ISSUED FOR BUILDING PERMIT

APR. 12, 2024 | ADDENDUM #1

LEGEND

EXISTING GRID TO REMAIN. (SHOWN TONED)

DO NOT SCALE DRAWINGS.

EXISTING CONSTRUCTION TO REMAIN.

NOTES APPLY TO ALL DEMOLITION & PROPOSED DRAWINGS INCLUDING MECHANICAL AND ELECTRICAL DRAWINGS CONTRACTORS & SUBTRADE, INCLUDING MECH & ELEC TRADES SHALL READ THE WHOLE SET TOGETHER BEFORE PRICING. GC TO CONFIRM

- REFER TO A100 FOR GENERAL NOTES.
- REFER TO A100 FOR REFERENCE/TAGS
- REFER TO D201, D203, A201, A203, A500 & A800 FOR NOTES
- REFER TO A501 FOR FLOORING FINISH PATTERN

DEMOLITION OF HAZARDOUS MATERIALS TYPICAL:

G.C. TO REFER TO HAZARDOUS BUILDING MATERIALS ASSESSMENT REPORT ALONG WITH SPECIFICATIONS AND CONTRACT DOCUMENTS PREPARED BY PINCHIN REGARDING THE REMOVAL AND DEMOLITION OF HAZARDOUS MATERIALS.





 $\square M \lor$ GROUP =architects

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CLASSROOMS 233-235-244-245-246-247 RENOVATION KAWARTHA PINE RIDGE DISTRICT SCHOOL BOARD

DR MS HAWKINS SR.PS

130 HIGHLAND DRIVE PORT HOPE

OM

PARTIAL FLOOR PLAN

Date Plotted Apr 16, 2024 - 2:09pm **AS NOTED** evision No.

A200

ARCH D

TO ARCH, STR, MECH & ELEC DRAWINGS.

- WHERE REQUIRED.
- RECESSED ELECTRICAL PANELS, AND F.E.C.
- 6. REMOVE & RESTORE OR REPLACE ALL CEILINGS AFFECTED BY ACCESS TO MECH. & SERVICES. SEE & ELECT. DWGS
- WHERE EXISTING FLOORING FINISHES ARE REMOVED, ALLOW

CLASSROOM 241

CLASSROOM 242

CLASSROOM 240

GIRLS W.R

236 PC

BOYS W.R


RESOURCES 234

COND FLOOR PLAN


ROOF

H. PAINTING & REPAINTING: PREPARE SUBSTRATES TO ACCEPT NEW

ROUGH-INS SHALL BE COORDINATED WITH MILLWORK SHOPDWG

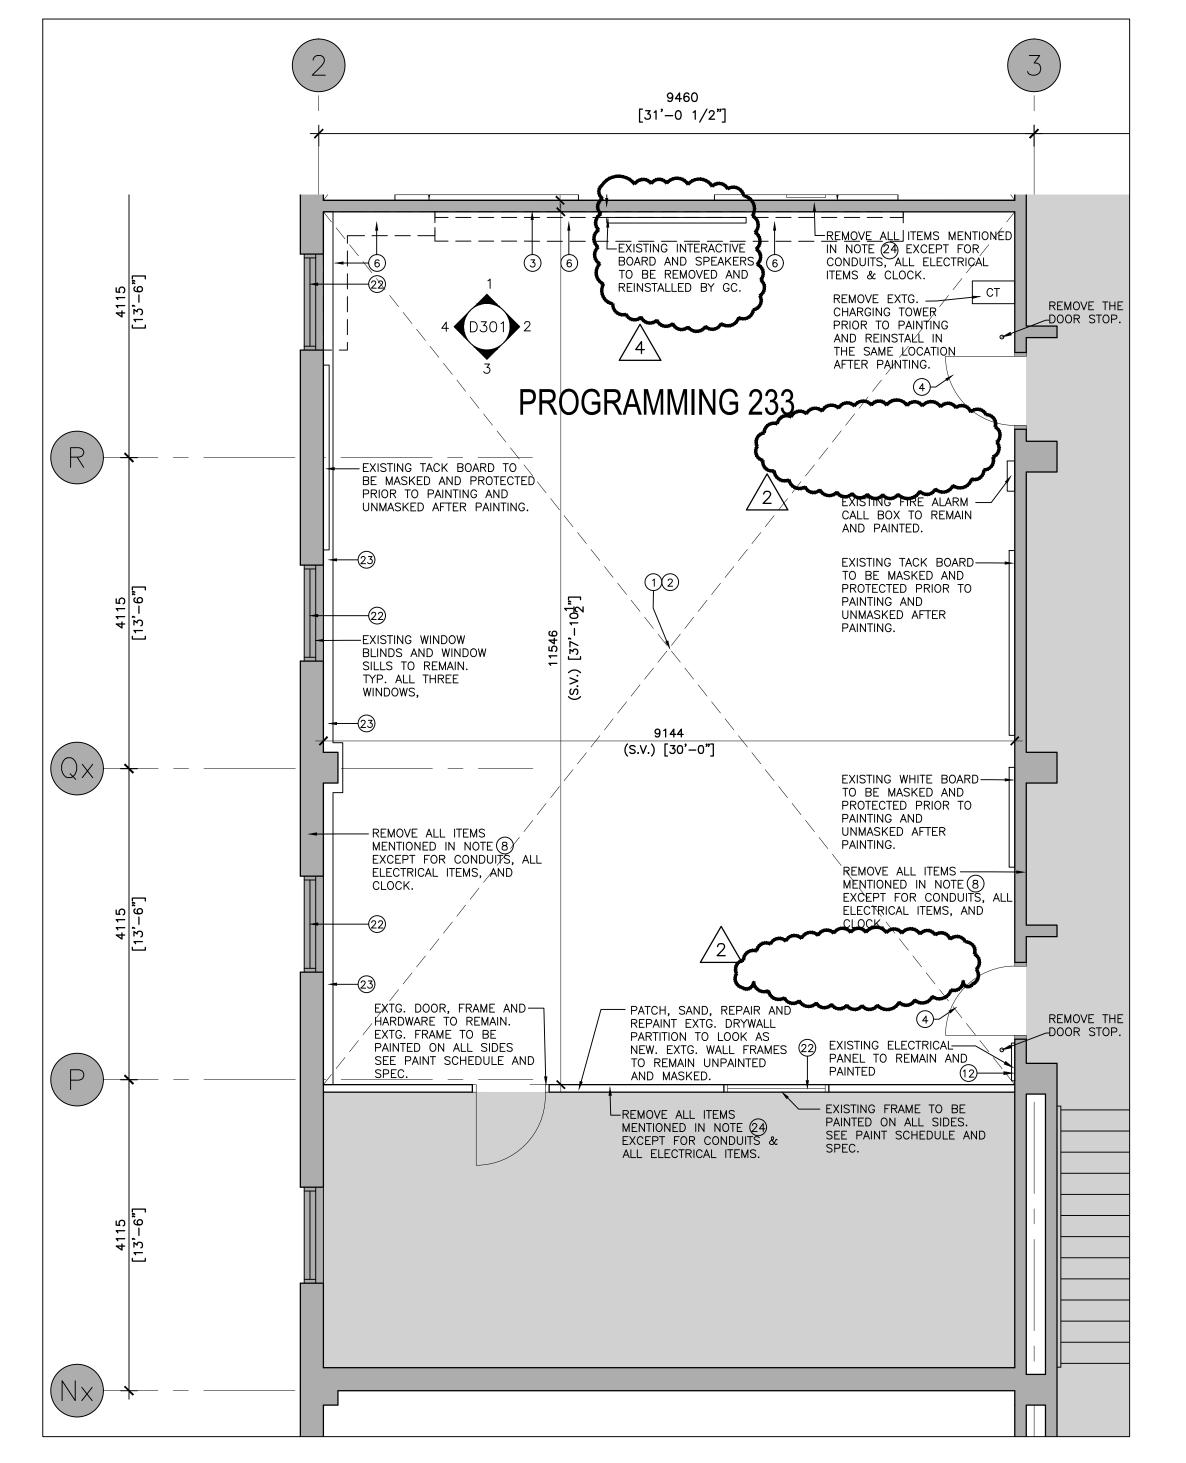

CLASSROOM 233 DEMOLITION FLOOR PLAN SCALE: 1:50

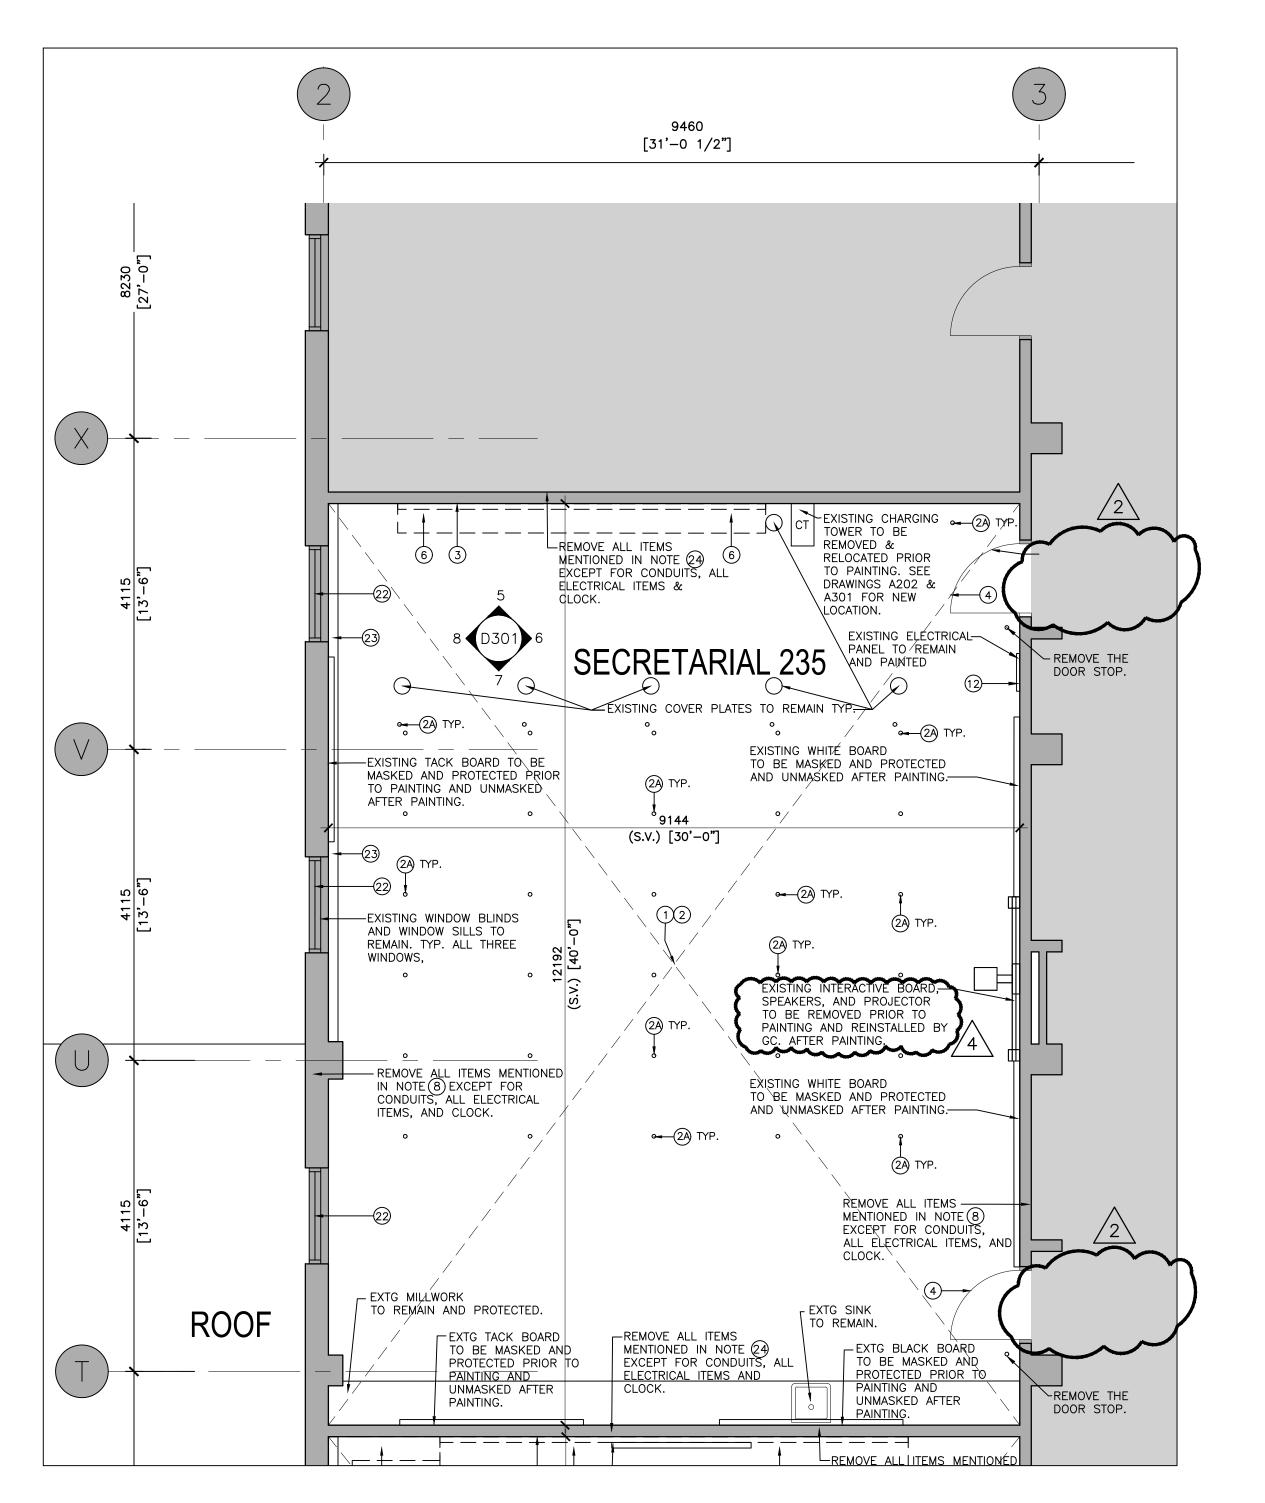

CLASSROOM 235 DEMOLITION FLOOR PLAN D202 SCALE: 1:50

ALL DRAWINGS ARE THE PROPERTY OF THE ARCHITECT AND MUST BE RETURNED ON REQUEST. THE CONTRACTOR SHALL CHECK ALL DIMENSIONS AND REPORT DISCREPANCIES TO THE ARCHITECT.

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REVISIONS AND DISTRIBUTION LOG No. Date MAR. 12, 2024 ISSUED FOR TENDER APR. 12 2024 ADDENDUM #1 3 APR. 15, 2024 ISSUED FOR BUILDING PERMIT APR. 16, 2024 | ADDENDUM #2

LEGEND

EXISTING CONSTRUCTION TO REMAIN.

EXISTING GRID TO REMAIN. (SHOWN TONED)

REFER TO DRAWING A200

FOR REFERENCE NOTES. (TYPICAL)

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DEMOLITION OF HAZARDOUS MATERIALS TYPICAL:

G.C. TO REFER TO HAZARDOUS BUILDING MATERIALS ASSESSMENT REPORT ALONG WITH SPECIFICATIONS AND CONTRACT DOCUMENTS PREPARED BY PINCHIN REGARDING THE REMOVAL AND DEMOLITION OF HAZARDOUS MATERIALS.







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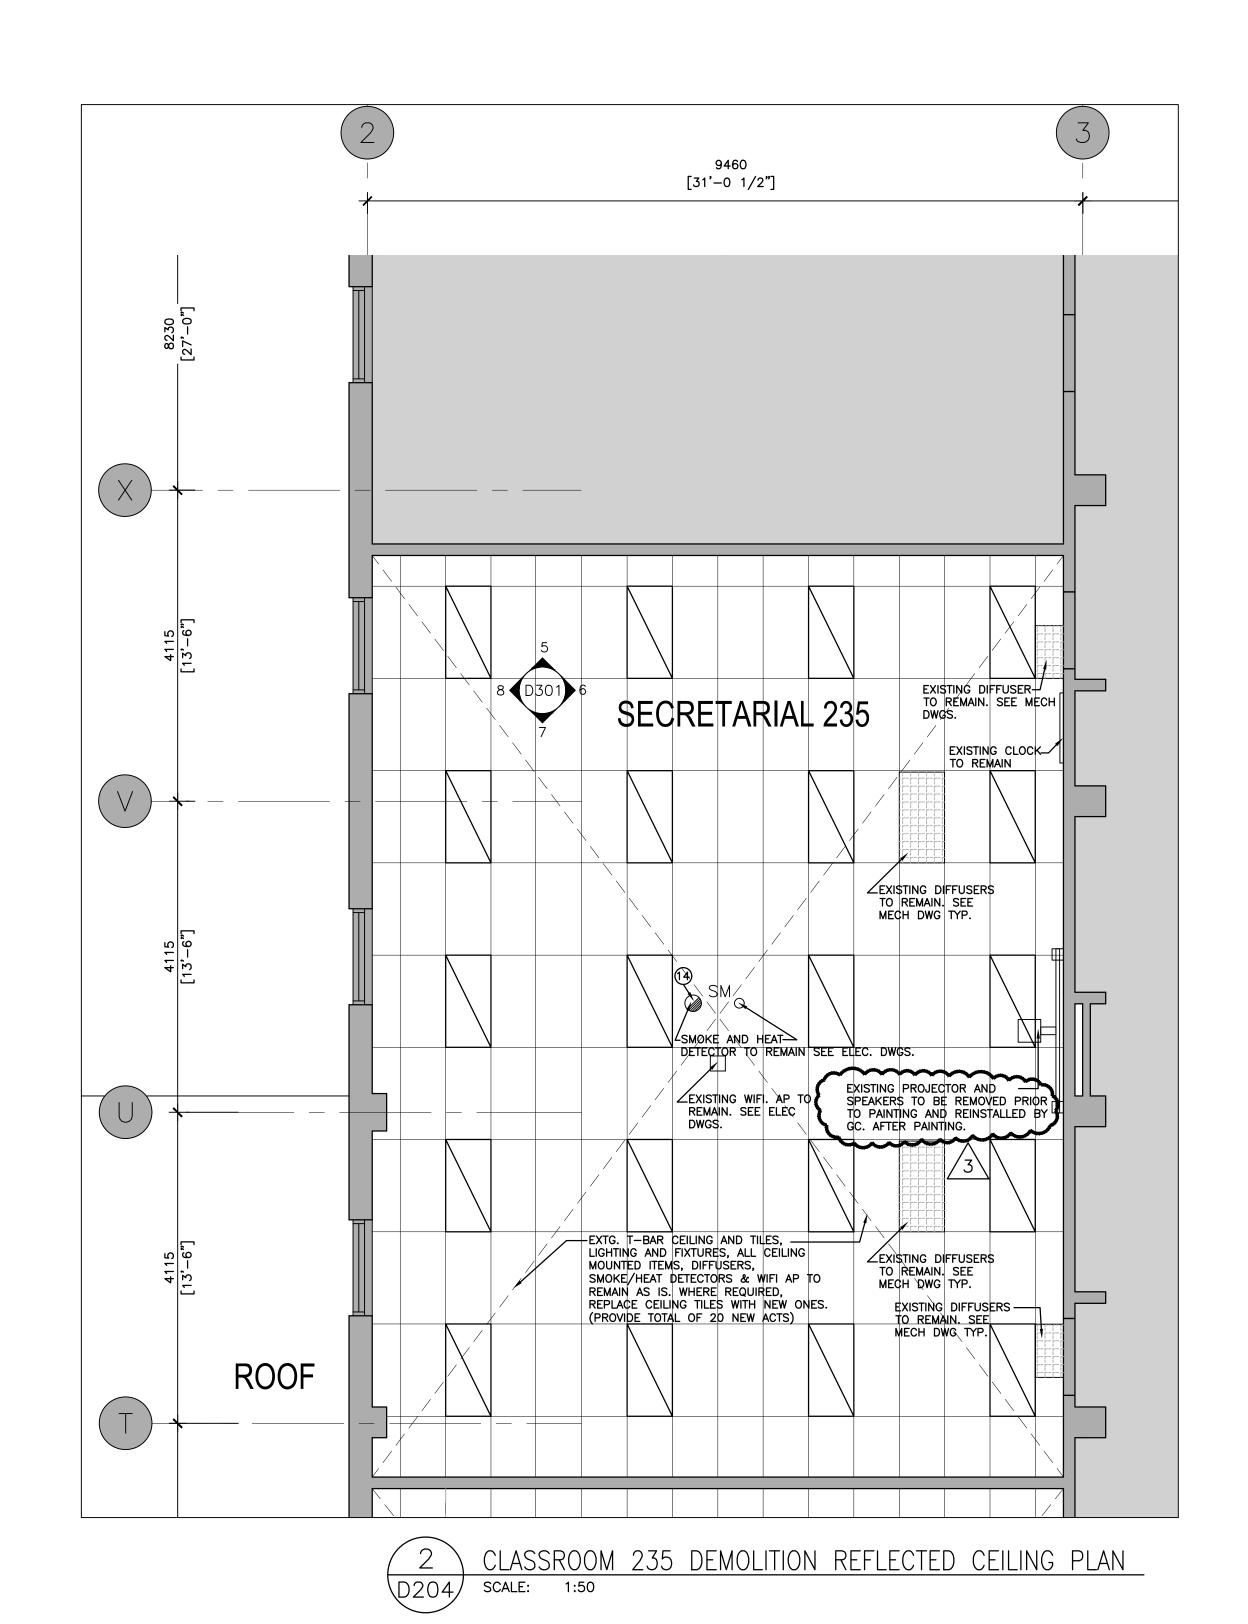
CLASSROOMS 233 AND 235 DEMOLITION FLOOR PLAN

Drawn By: TJ	Checked By:	Date Checked:	Project No. 23A117
Date Plotted: Apr 17, 2024 - 2:31pm			Scale: AS NOTED
Drawing No.:			Revision No.:

ARCH D

CLASSROOM 233 DEMOLITION REFLECTED CEILING PLAN

SCALE: 1:50



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	REVISIONS AND DISTRIBUTION LOG		
No.	Date	Note	
1	MAR. 12, 2024	ISSUED FOR TENDER	
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3	APR. 16, 2024	ADDENDUM #2	

LEGEND



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REFER TO DRAWING A200 FOR REFERENCE NOTES. (TYPICAL)

EXISTING GRID TO REMAIN. (SHOWN TONED)

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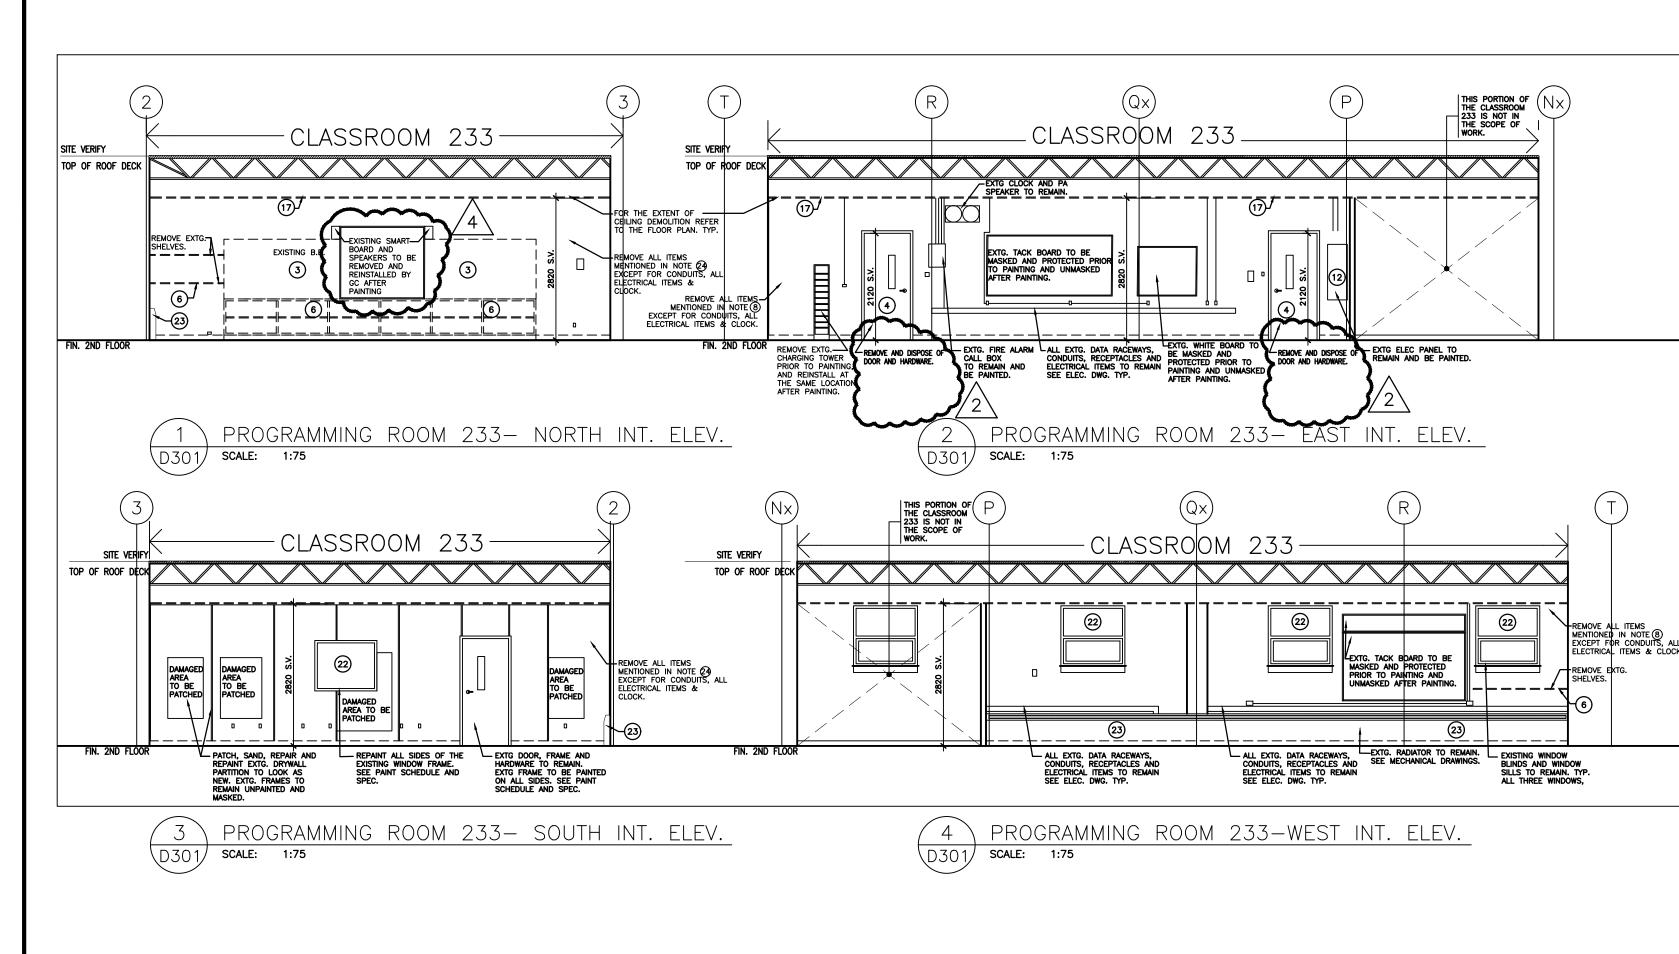
130 HIGHLAND DRIVE PORT HOPE


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CLASSROOMS 233 AND 235 DEMOLITION REFLECTED CEILING PLAN

Drawn By:	Checked By:	Date Checked:	Project No.
TJ	ОМ		23A117
Date Plotted:	Scale:		
Apr 17, 2	AS NOTED		
Drawing No.:	Revision No.:		
	3		

ARCH D



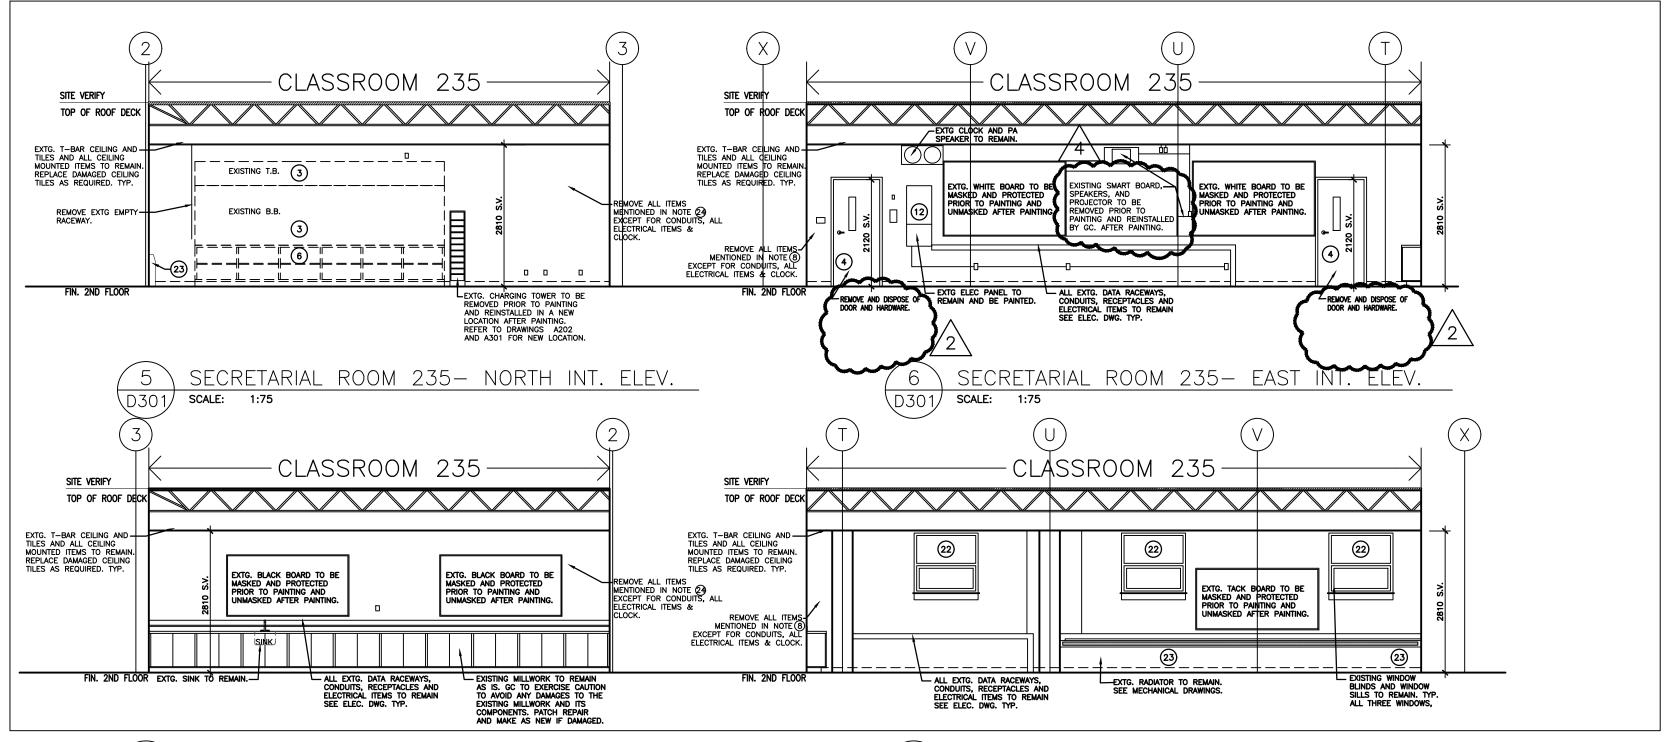

7 SECRETARIAL ROOM 235— SOUTH INT. ELEV. D301 SCALE: 1:75

8 SECRETARIAL ROOM 235—WEST INT. ELEV. D301 SCALE: 1:75

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REVISIONS AND DISTRIBUTION LOG

		<u></u>
No.	Date	Note
1	MAR. 12, 2024	ISSUED FOR TENDER
2	APR. 12, 2024	ADDENDUM #1
3	APR. 15, 2024	ISSUED FOR BUILDING PERMIT
4	APR. 16, 2024	ADDENDUM #2

REFER TO DEMO FLOOR PLANS (D200 SERIES) AND PROPOSED FLOOR PLANS (A200 SERIES) FOR SCOPE OF DEMOLITION. (TYPICAL)

REFER TO A200 FOR PREFERENCE NOTES (TYPICAL)

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CLASSROOMS 233-235-244-245-246-247 RENOVATION
KAWARTHA PINE RIDGE DISTRICT SCHOOL BOARD


130 HIGHLAND DRIVE PORT HOPE


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DEMOLITION INTERIOR ELEVATIONS

Drawn By:	Checked By:	Date Checked:	Project No.
TJ	ОМ		23A117
Date Plotted:			Scale:
Apr 16, 2024 - 2:11pm			AS NOTED
Drawing No.:			Revision No.:
	4		





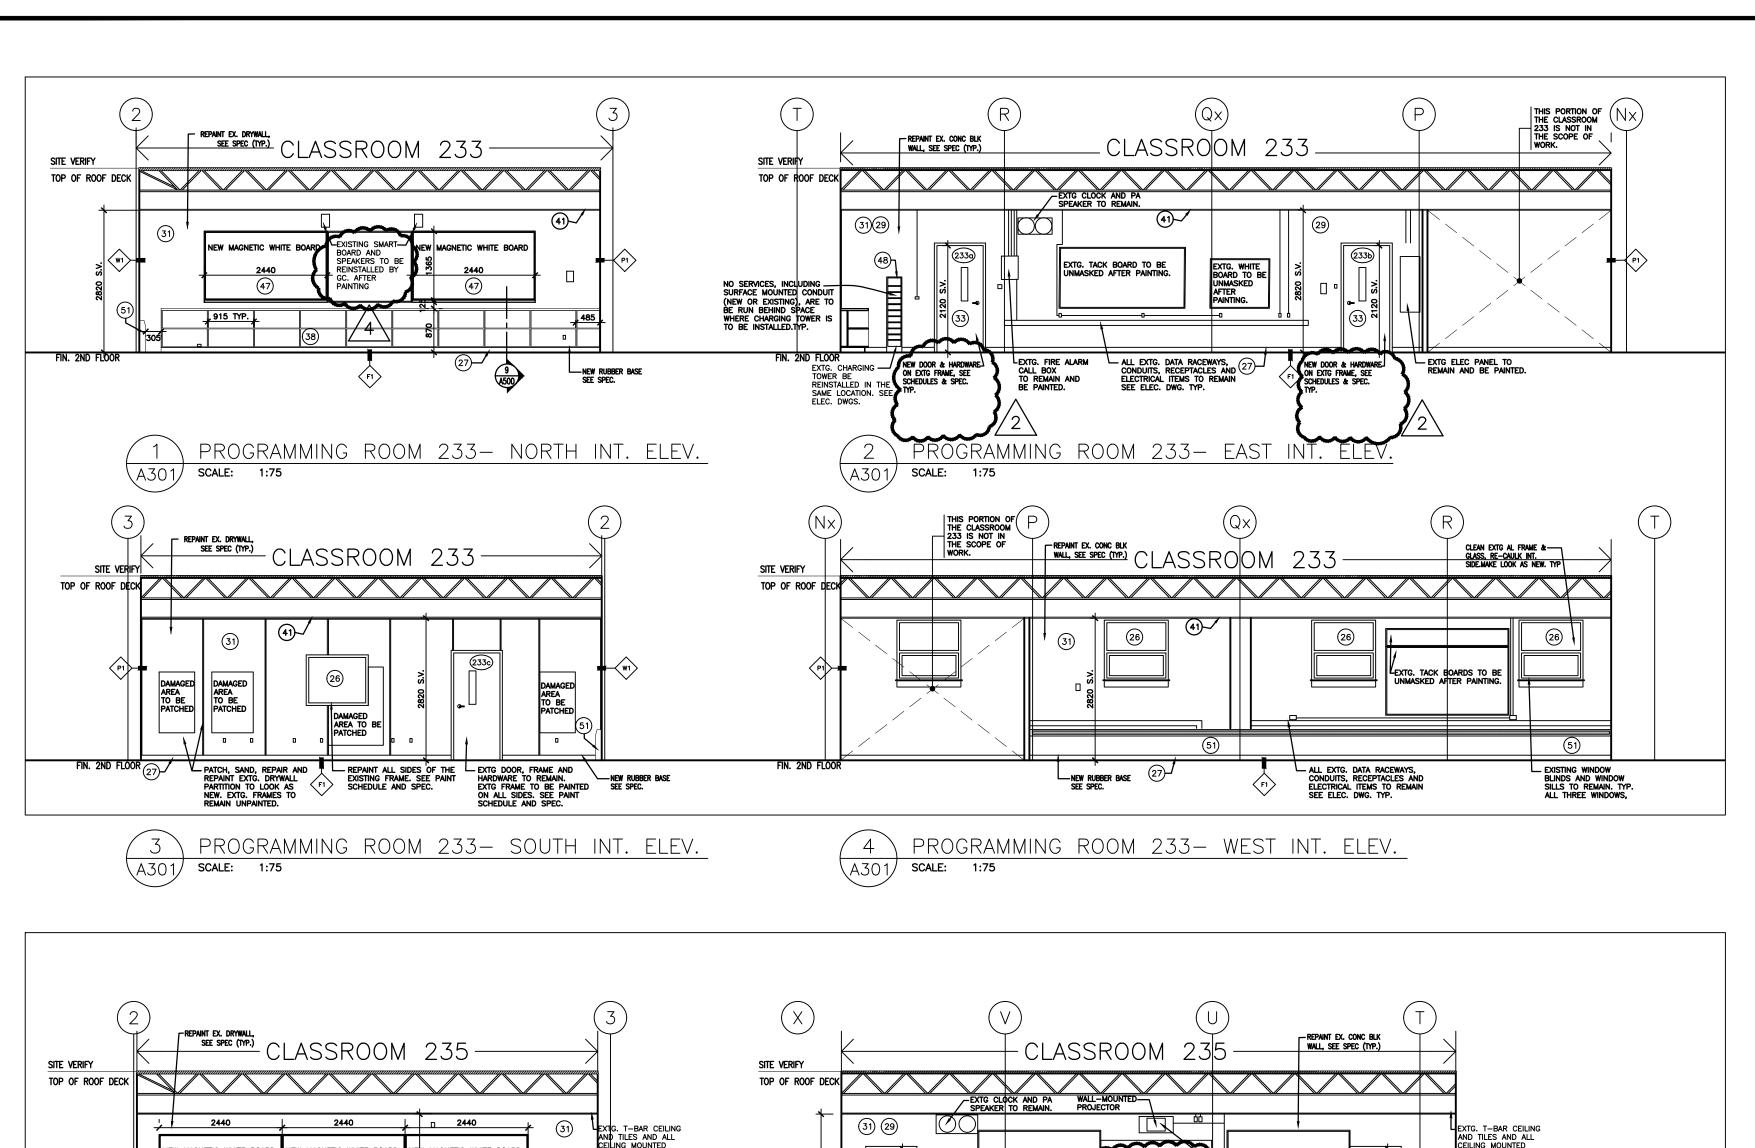

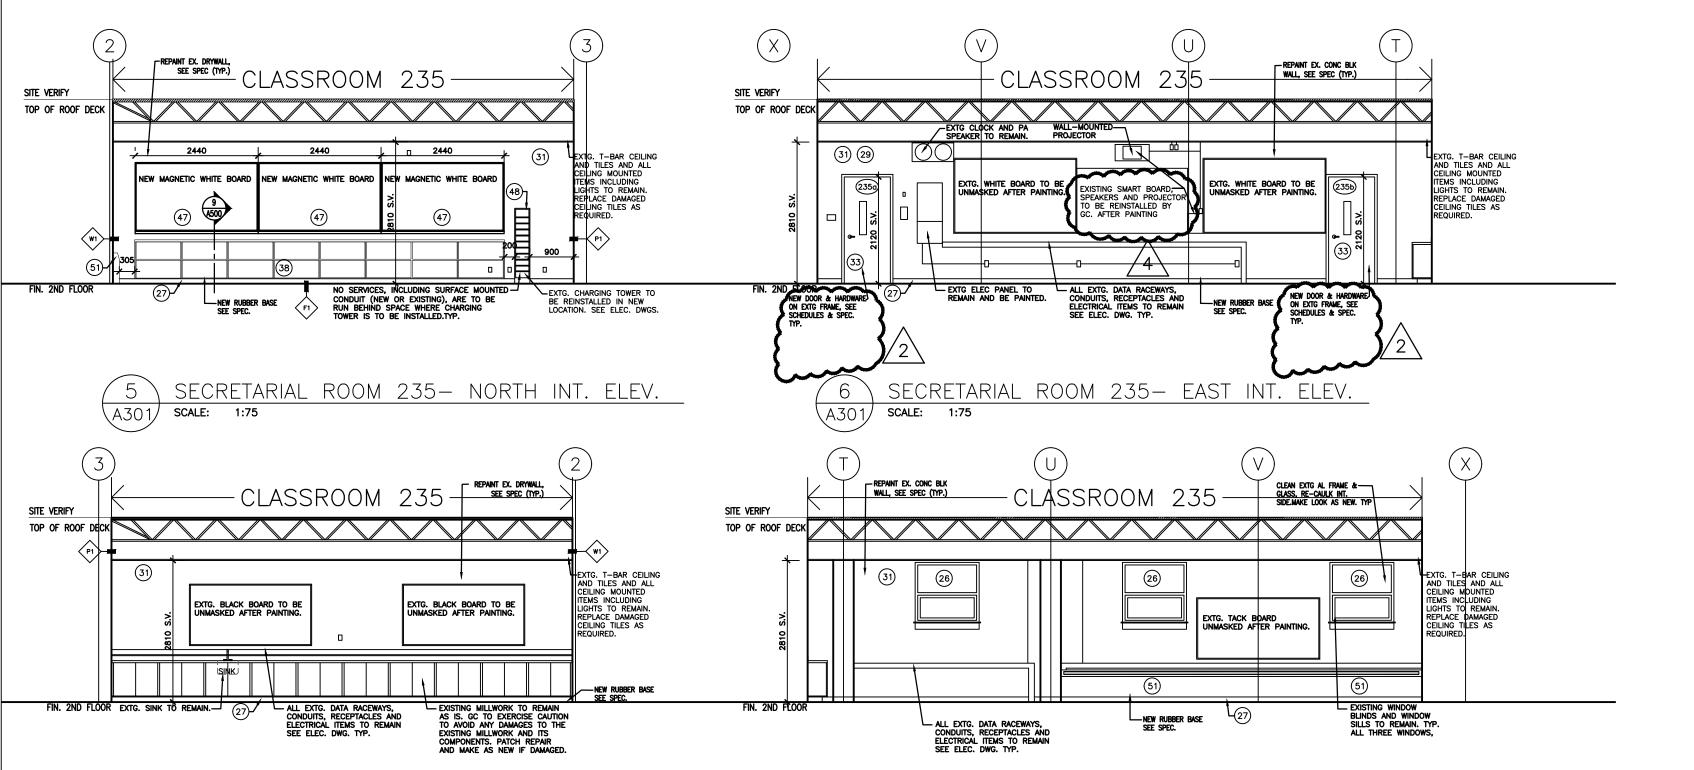7 SECRETARIAL ROOM 235— SOUTH INT. ELEV.
A301 SCALE: 1:75

8 SECRETARIAL ROOM 235— WEST INT. ELEV.
A301 SCALE: 1:75

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DO NOT SCALE DRAWINGS.

No.	Date	Note
1	MAR. 12, 2024	ISSUED FOR TENDER
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REFER TO DEMO FLOOR PLANS
(D200 SERIES) AND PROPOSED
FLOOR PLANS (A200 SERIES)
FOR SCOPE OF DEMOLITION.
(TYPICAL)

REFER TO A200 FOR PREFERENCE NOTES (TYPICAL)

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DEMOLITION OF HAZARDOUS MATERIALS TYPICAL:

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Project:
DR MS HAWKINS SR.PS

CLASSROOMS 233-235-244-245-246-247 RENOVATION
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PROPOSED INTERIOR ELEVATIONS

Drawn By:	Checked By:	Date Checked:	Project No.
TJ	OM		23A117
Date Plotted:	Scale:		
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Drawing No.:			Revision No.:
	4		



101 – 20 Camden Street Toronto, Ontario M5V 1V1

ADDENDUM

416.506.1600 416.506.0956

www.cmvarch.com

DATE April 17, 2024

ADDENDUM No

3

PROJECT Dr M.S. Hawkins Sr Public School Classroom Renovations

PROJECT No 23A117

Kawartha Pine Ridge District School Board1994 Fisher DrivePeterborough, ON K9J 6X6

ATTENTION Steven Altpeter

- 02 Receipt of the Addenda shall be acknowledged in the Tender Form.
- 03 All trades shall read the Addenda.
- 04 This addendum consists of 4 pages and attachments as noted.

Refer to Mechanical Addendum M-1 dated April 16, 2024, by TMP attached.

Tala Jabbary		
PFR CMV GROUP ARCHITECTS	 	

Andrew Ferreira -TMP, Quan Vu - H&J

⁰¹ This Addendum shall be attached to the form of the Specifications and shall form an integral part of the Contract Documents. The contents of this Addendum shall be brought to the attention of all concerned.



MECHANICAL ADDENDUM

200 KING ST. W., SUITE 310, TORONTO, ON CANADA M5H 3T4 E tmp@tmptoronto.com | P 416-499-8000

SUBJECT	Mechanical Addendum M-1	
PROJECT NO.	23-1109-000	
PROJECT	Dr. MS Hawkins Public School - Classi	rooms 244, 246, 247, 247
ATTENTION	Otto Miller	
ТО	CMV Group Architects 20 Camden Street, Suite No. 101 Toronto, ON M5V 1V1	ADD - M-1
DATE	April 16, 2024	

Include the following changes in the pricing and work of this project.


1.0 DRAWINGS

- 1.1 Drawing No. M1-101 Classrooms 244 to 247 Mechanical Demolition (re-Issued)
- 1.2 Drawing No. M1-201 Classrooms 244 to 247 Mechanical New (re-Issued)

2.0 DESCRIPTION

- 2.1 Drawing No. M1-101
 - .1 Revised drawing to illustrate removal of four (4) existing room temperature sensors.
- 2.2 Drawing No. M1-202
 - .1 Updated drawing to illustrate the relocation of four (4) existing room temperature sensors,

END OF MECHANICAL ADDENDUM NO. M-1

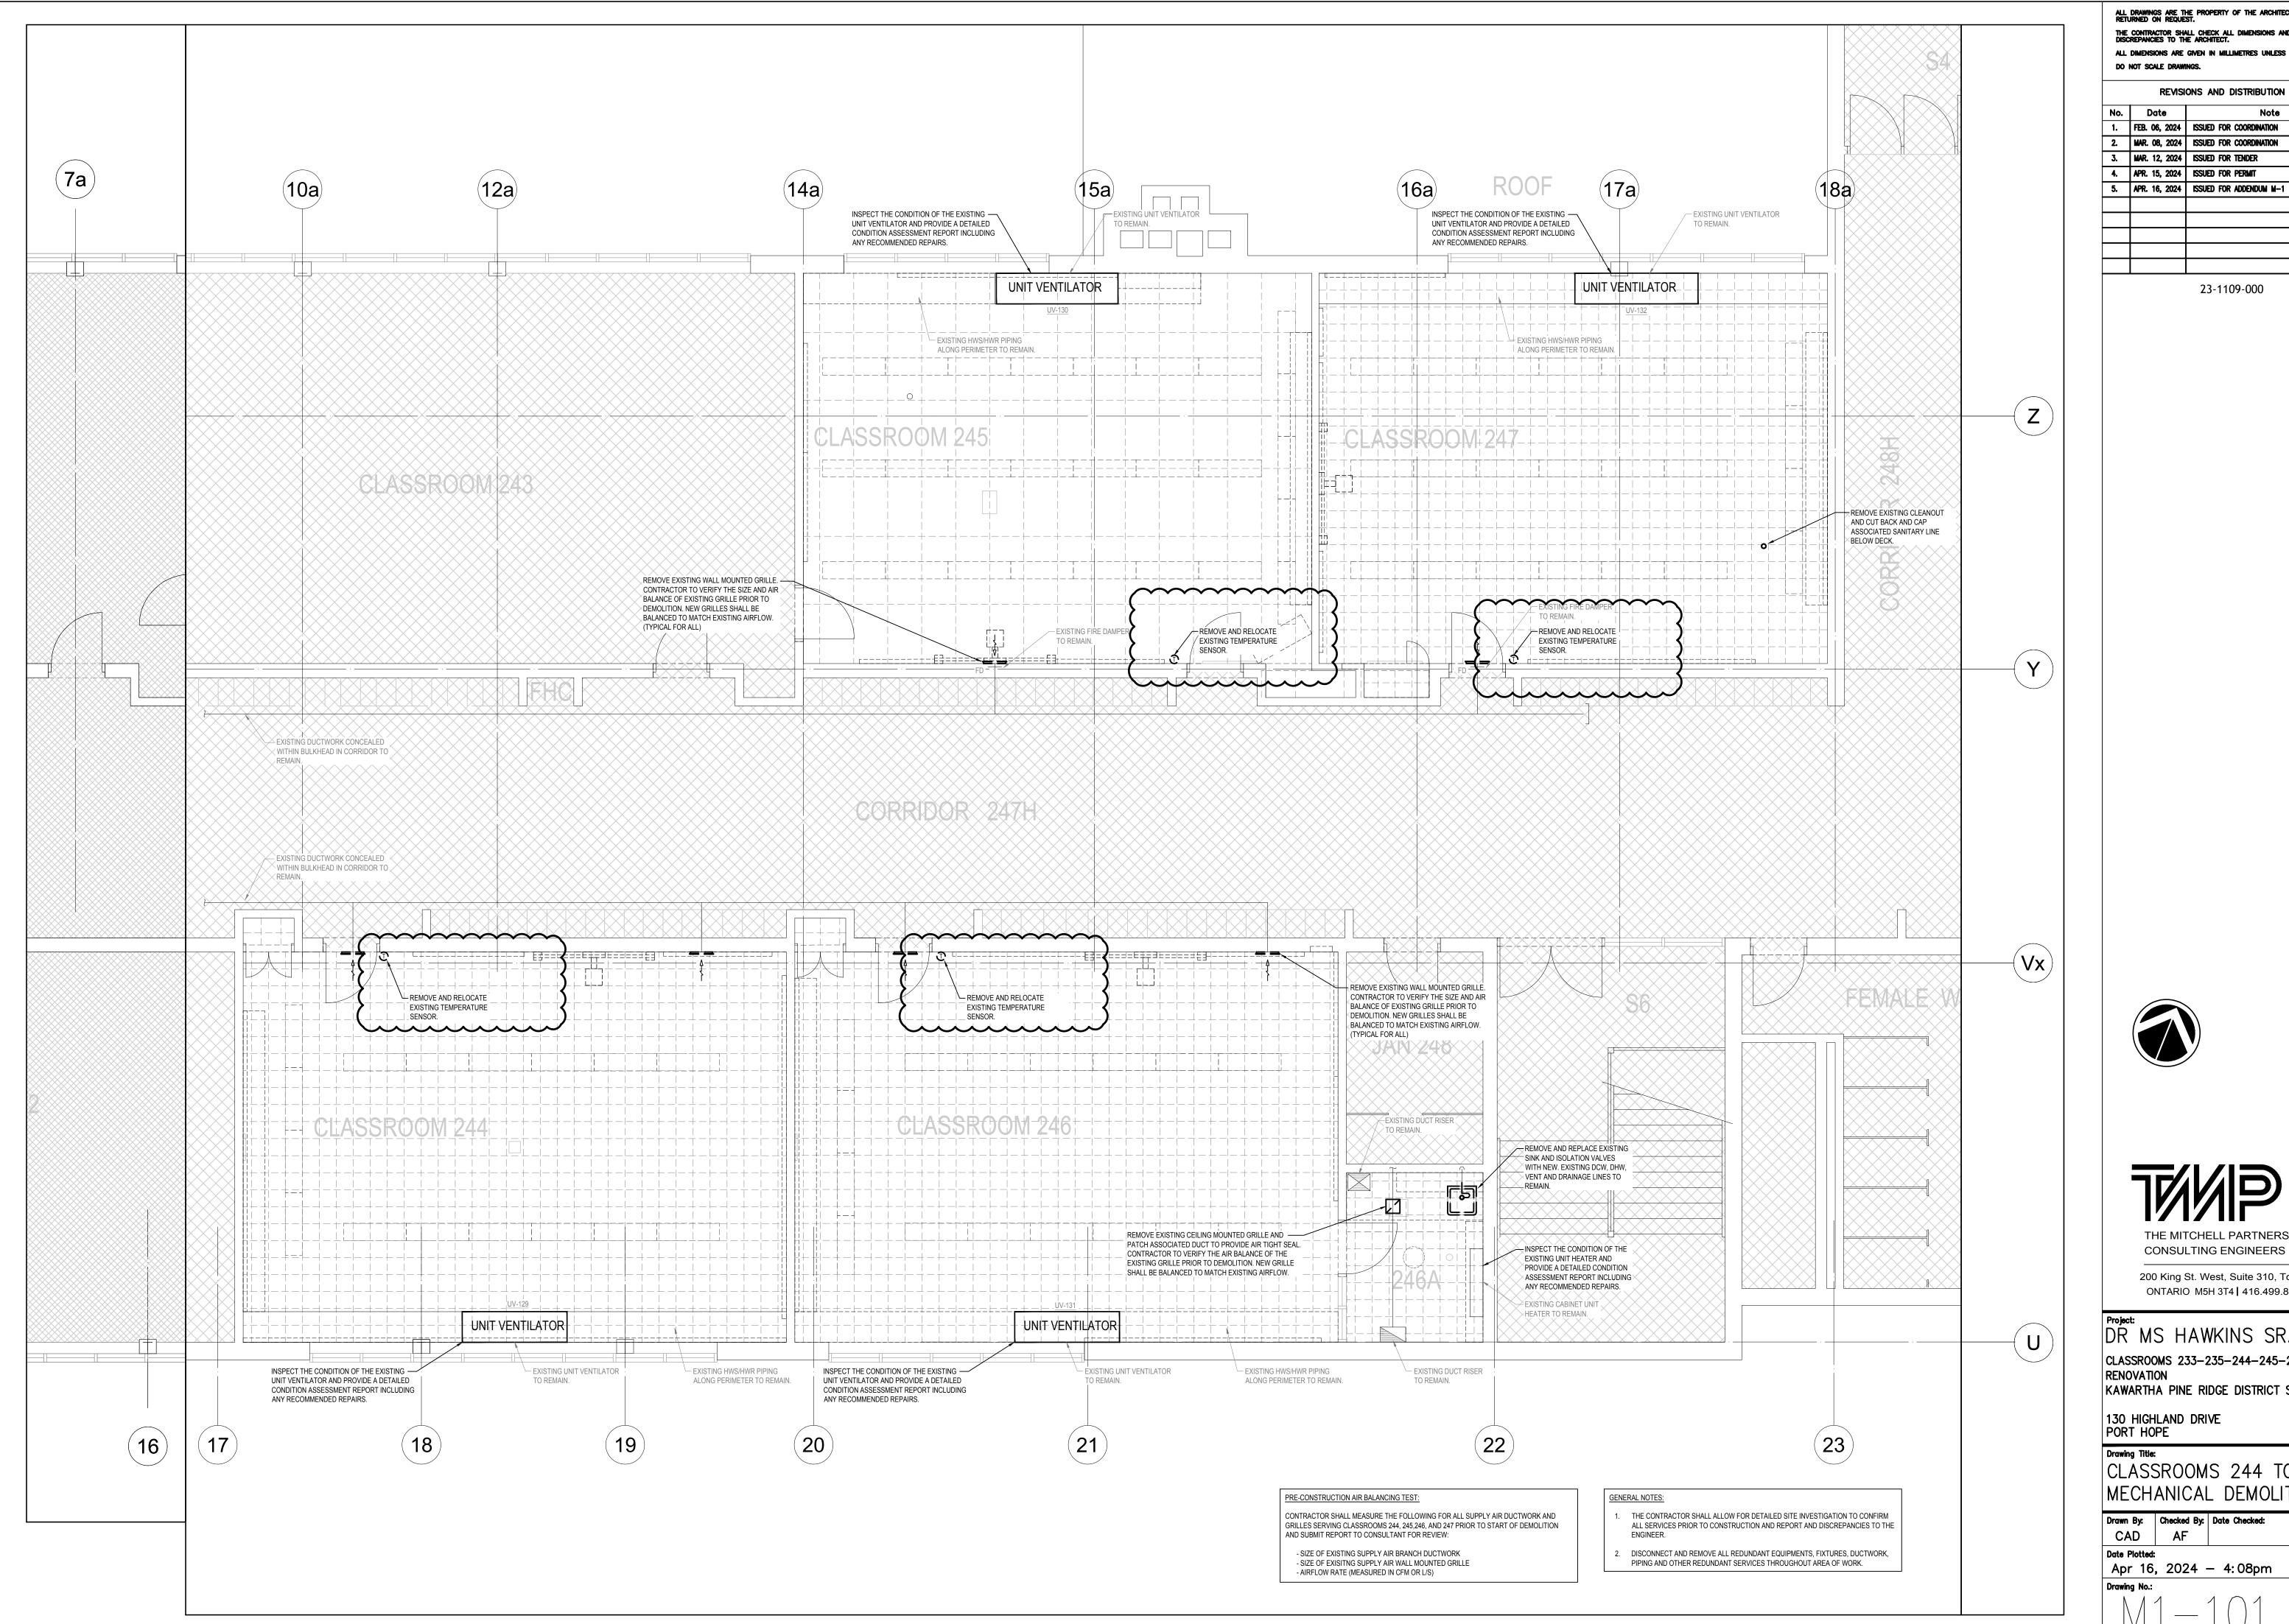

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REVISIONS AND DISTRIBUTION LOG Date 1. FEB. 06, 2024 ISSUED FOR COORDINATION 2. MAR. 08, 2024 ISSUED FOR COORDINATION 3. MAR. 12, 2024 ISSUED FOR TENDER 4. APR. 15, 2024 ISSUED FOR PERMIT 5. APR. 16, 2024 | ISSUED FOR ADDENDUM M-1

23-1109-000



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Project:
DR MS HAWKINS SR.PS CLASSROOMS 233-235-244-245-246-247 RENOVATION KAWARTHA PINE RIDGE DISTRICT SCHOOL BOARD


130 HIGHLAND DRIVE PORT HOPE

CLASSROOMS 244 TO 247

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MECHANICAL DEMOLITION Drawn By: Checked By: Date Checked:

CAD Apr 16, 2024 - 4:08pm 1:50

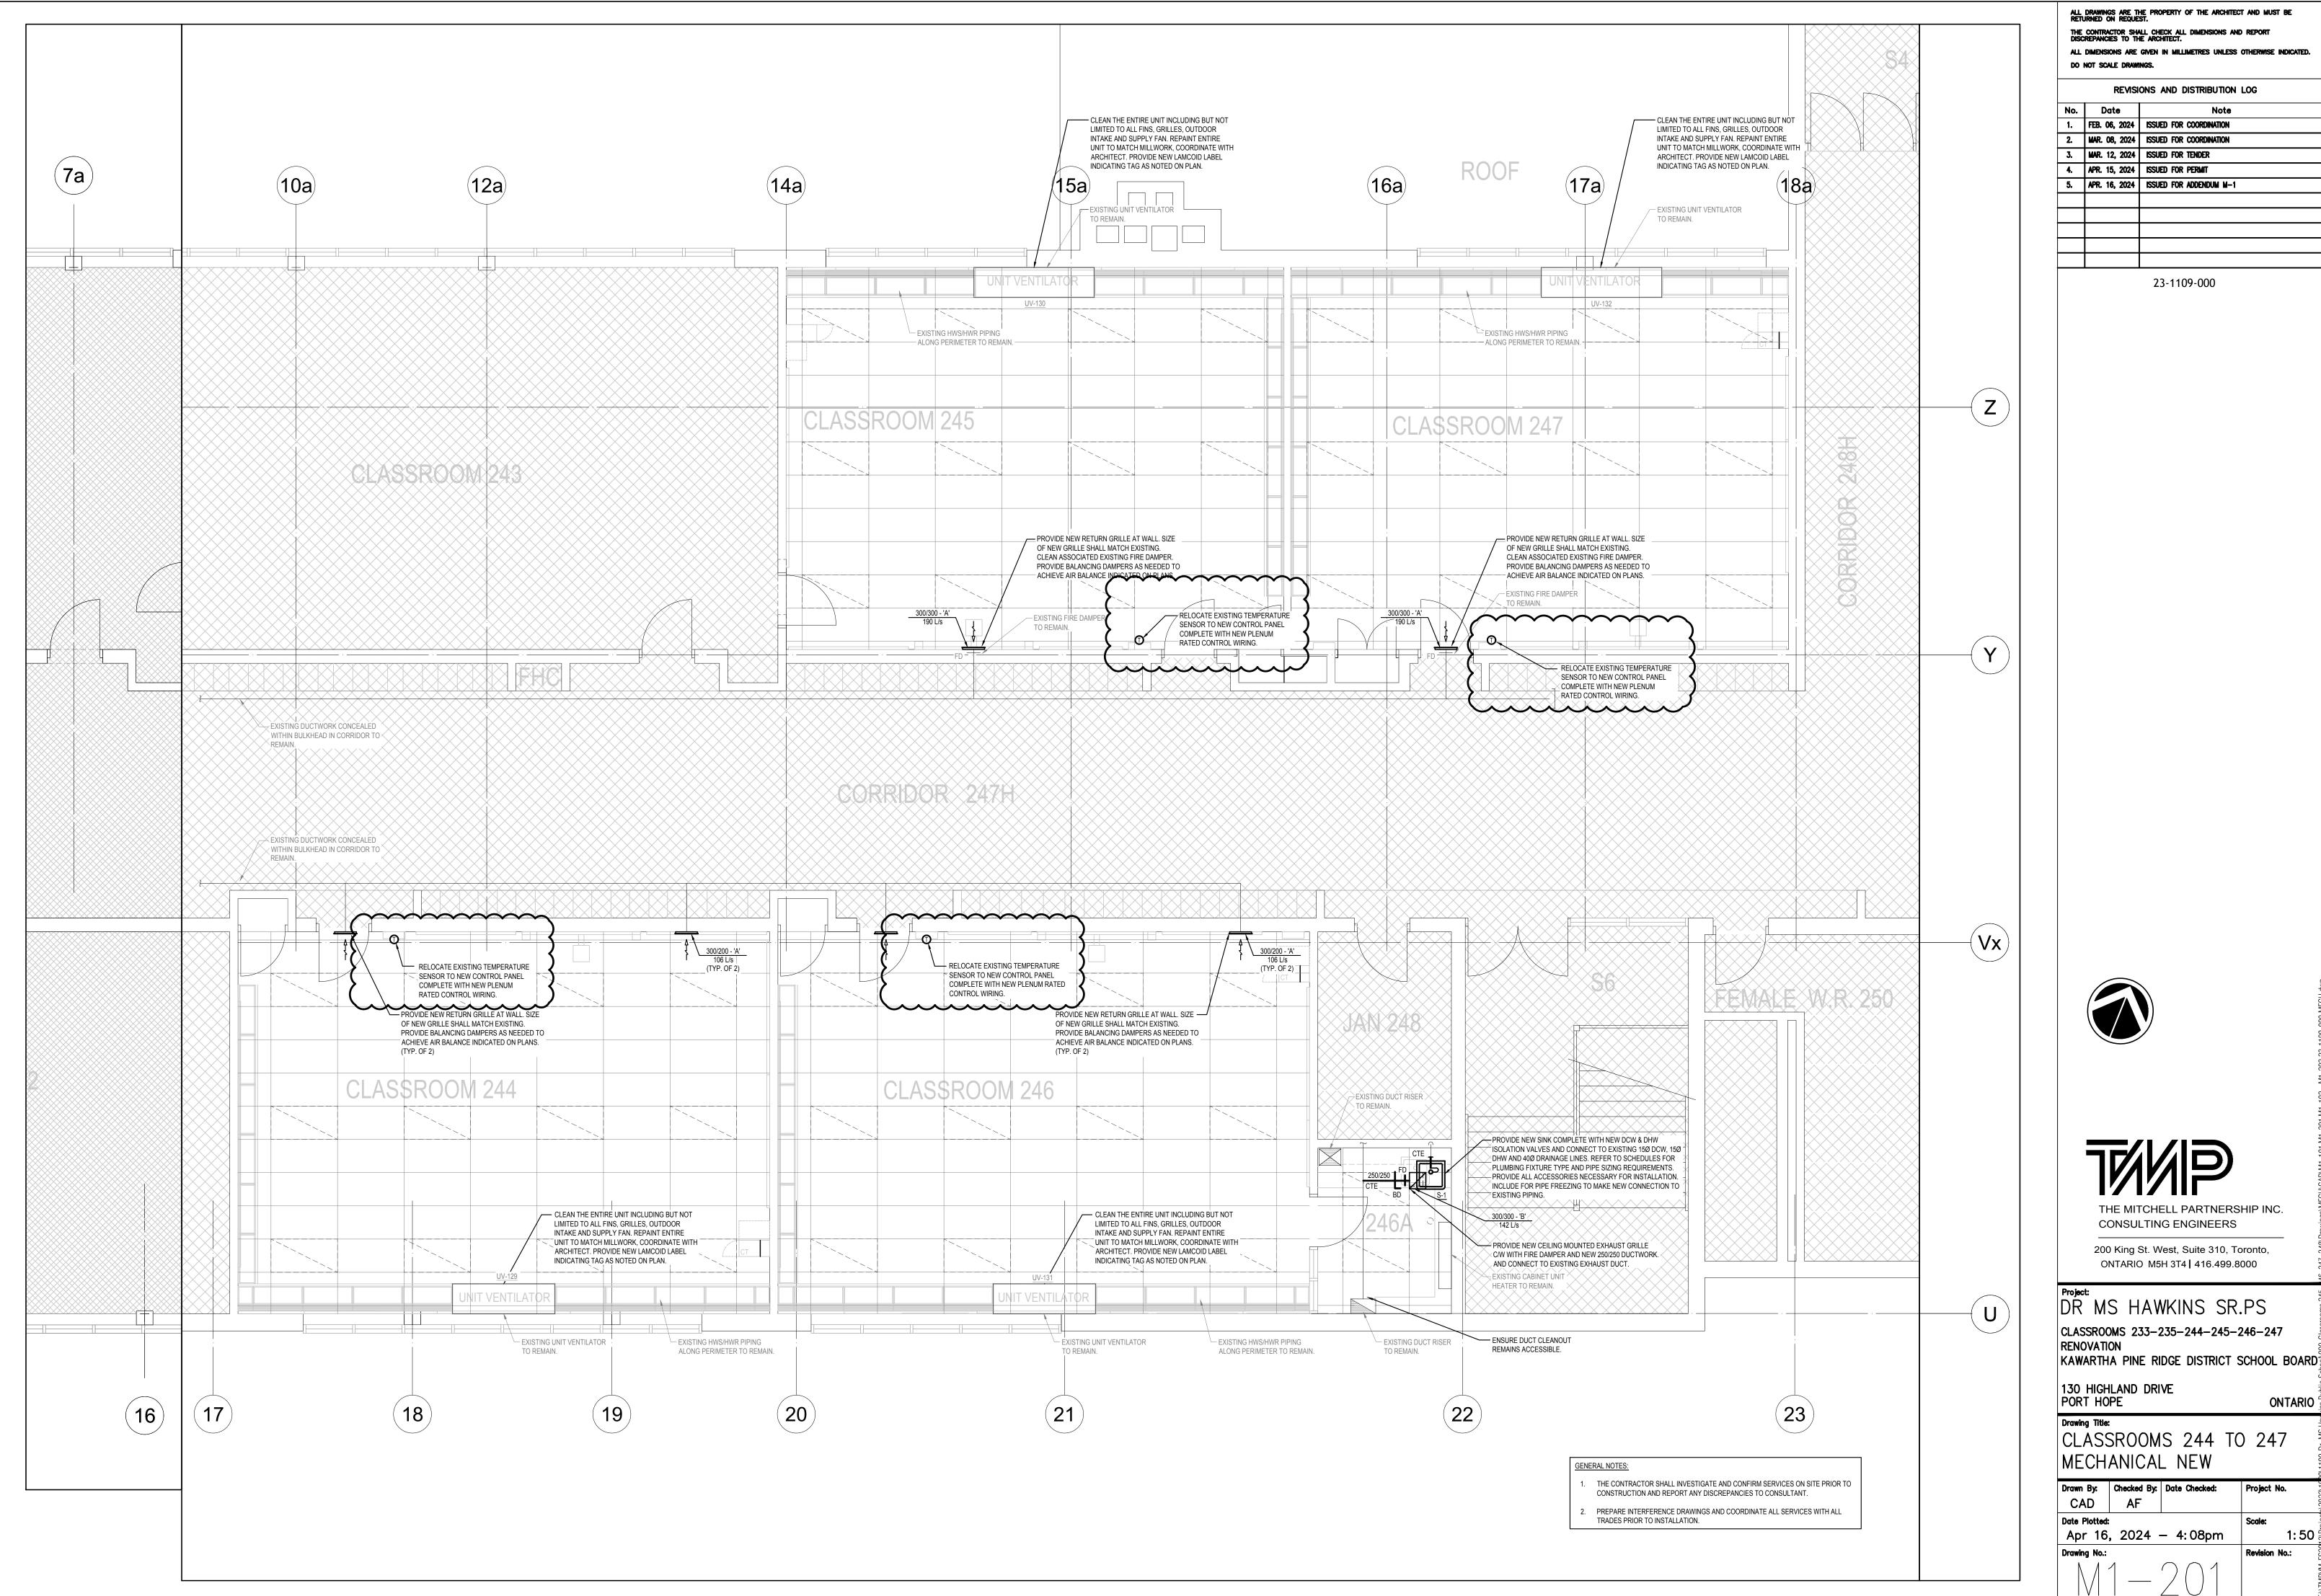

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23-1109-000



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1:50

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DR MS HAWKINS SR.PS CLASSROOMS 233-235-244-245-246-247 RENOVATION

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Drawing Title: CLASSROOMS 244 TO 247 MECHANICAL NEW

Drawn By: Checked By: Date Checked: Project No. CAD

Apr 16, 2024 - 4:08pm